

# SASAKI



Mississippi State University
Exterior Signage and Wayfinding
Specifications + Guidelines

Updated February 2023 – Issued April 2023

# **How to Use This Document**

When considering a new project or renovation on the campus, use the following resources to understand the full image of the design. Consult the Campus Master Plan to understand the larger framework in which the project will be constructed both today and in the future. Consult the relevant campus guidelines, including this document, to understand the specific intent and character of each design element. Consult the standard university specifications and details to understand the specific implementation requirements for each element.

Designers should always consult the campus services to better understand the purpose of the guidelines and their relationship to other planning documents. Most of this document represent adopted standards, which will allow the Mississippi State University to expedite design decisions, reduce maintenance, and ultimately make the campus look more consistent. However, every situation is unique and design decisions will have to be made that bend, and even potentially break, the standards. Therefore, this document is a set of guidelines that should only be broken after carefully considering the site context and the pros and cons of implementing the adopted standard.

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# Relationship to the Master Plan

The Master Plan defines the flexible framework in which the campus will grow in the future. These guidelines, on the other hand, define how specific elements will be executed within the larger master plan. This document includes all University guidelines related to the exterior environments of the campus. For example, information on where to new pedestrian malls should be located, see the Master Plan. For information on what they should look like and how they should function, you're in the right place.

# Relationship to Campus Specifications and Details

Campus Services is the keeper of all specifications and details on the campus. This document provides the character and intent for implementing each signage element, while the standard specifications and details provide specific instructions on how each element is to be installed. The specifications and details are technical and need to be modified frequently to stay with the most current regulatory requirements and changes in technologies. On the other hand, these guidelines are more subjective and provide a complete inventory of the adopted standard on the campus. They also give guidance as to where and when each element is implemented.



# One Campus Guide

The campus landscape, including all exterior design elements, is intended to be consistent across all districts of the campus. Within the Mississippi State University campus, there are several districts of the campus including the Historical Core, the Athletics District, and various research districts. Each has its own architectural style, building typologies, and spatial relationships. Using a consistent character and collection of design elements, the campus landscape unifies each of these districts into a single, recognizable identity. This strategy provides a consistent visual vocabulary to all campus visitors. It indicates that they are on campus as soon as they enter it – regardless of where they are within it. Small variations are expected within this vocabulary that do not change the guidelines, but rather raise the quality of the experience. For example, an element on the periphery of campus may be a less ornate version of the detailed version found at the campus core. This is a function of practicality and responsible resource allocation that serves to make the core the "gem" of the campus landscape.

# Where to Bend the Rules

There are two instances when a departure from the campus guidelines can be considered: when addressing the landscape of a special building or space on campus, and when the landscape "belongs" to a specific building and not to the campus. Like any environment, there are "ordinary" and "special" buildings and places. Special elements vary from ordinary ones in that they are shared by the entire campus community. The Colvard Union is an example of a special building on campus. It is a common gathering place for the entire community. When addressing a specific ordinary building's landscape, there may be opportunities to modify the campus guidelines to make it more unique to the needs of its occupants. In doing so, the designer must consider the degree to which the landscape belongs to the campus or the building. A courtyard is an example where the landscape is more relevant to the building than the campus. In each of these cases, it only takes modifying one or two standard elements in order to make a landscape unique. Beyond that, visual connection to the campus context begins to get lost. Typically, variations should only occur with ground plane elements such as plantings and paving materials. Changing light fixtures or other specific elements creates significant maintenance concerns.







# Existing Brand Standards and Material Selections

Mississippi State University Exterior Signage and Wayfinding Specifications + Guidelines

# **University Identification Marks**

# MISSISSIPPI STATE UNIVERSITY

# MISSISSIPPI STATE UNIVERSITY



# **Fonts**

All standard exterior signage shall utillize Futurua Medium or Futura Bold. Refer to signage specification sheets for font weight, capitalization, and alignment direction.

Futurua Medium

ABCEFGHIJKLMNOPQRSTUVWXYZ

abcdefghijklmnopqrstuvqyxz

Futurua Bold
ABCEFGHIJKLMNOPQRSTUVWXYZ
abcdefghijklmnopqrstuvqyxz

# **Symbols**



# **Font Exceptions**

All engraved or wall-mounted Building IDs to utilize Adobe Garamond Pro Semi-Bold. It is to be typeset with 50 PT letter spacing. See specification sheet for further details.

Adobe Garamond Pro Semi-Bold
ABCEFGHIJKLMNOPQRSTUVWXYZ
abcdefghijklmnopqrstuvqyxz



DATE

February 1*7*, 2023

#### NOTE

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PROJECT NAME

Mississippi State Univeristy Wayfinding and Signage Standards

SHEET TITLE

Brand and Graphics Standards

SHEET NUMBER

# **Paint Selections**

The colors shown represent Mississippi State University's primary exterior sign colors. All painted elements are to receive a UV rated and weather protection clear coating.




# **Powder Coat Selections**

The colors shown represent Mississippi State University's primary exterior sign colors. All powder coated elements to receive a UV rated and weather protection clear coating.



# **Vinyl Selections**

The colors shown represent Mississippi State University's primary exterior sign colors. All vinyl elements are to be finished with a UV protection laminate.

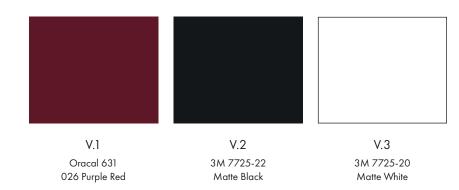

# **Material Selections**

The colors shown represent Mississippi State University's primary exterior materials. Any materials outside of these recommendations must be approved by Campus Services.





DATE

February 17, 2023

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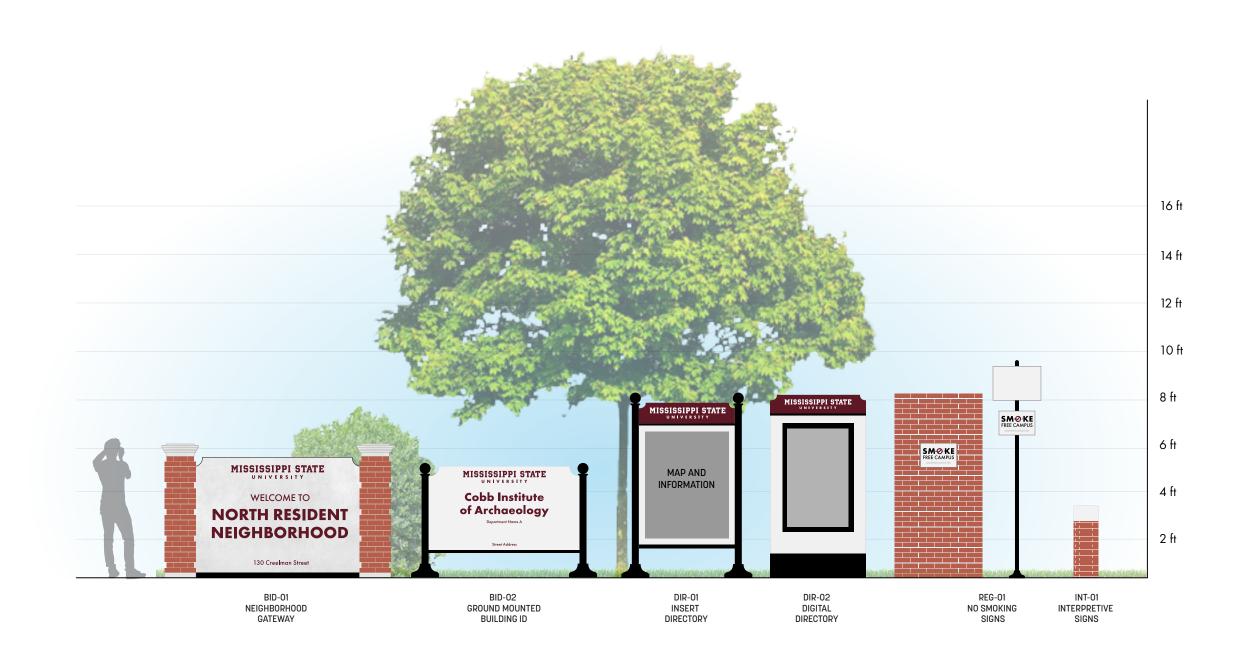
# Signage and Wayfinding Specification Drawings

Mississippi State University Exterior Signage and Wayfinding Specifications + Guidelines

# **Campus Sign Guidelines**

The goals of these campus sign guidelines are to reduce sign pollution, simplify and standardize signs, improve campus appearance, create a unified campus identity, and provide a clear wayfinding hierarchy. The following guidelines apply to selection and installation of all exterior fixtures on campus. Reference Office of Planning, Design, and Construction Administration standard details and specifications for all signs. All regulatory signs and markings on the campus must comply with MDOT standards for placement, color, and finish, etc. Consider the actual need for each sign, does another sign serve the same purpose? Use stenciled curb markings for a single service vehicle parking space only. Multiple space should be denoted with standard parking signs. No other curb or bumper stencil painting is prohibited. Use one lot designation sign at each entrance. Do not place signs internal to the lots. Remove event parking barricades to a non-visible location and stack them after each event (consider a three day baseball tournament one event). All temporary even parking signs should use the campus standard black metal sign frame. All permanently reserved parking spaces must be approved by the director of Parking Services. Temporary signs/banners advertising an event must be removed the day after the event by the organizer of the event. Permanent signs and banners on poles lining the streets and entrances are designed by Media Relationships and maintained by Facilities Management.







DATE

February 1*7*, 2023

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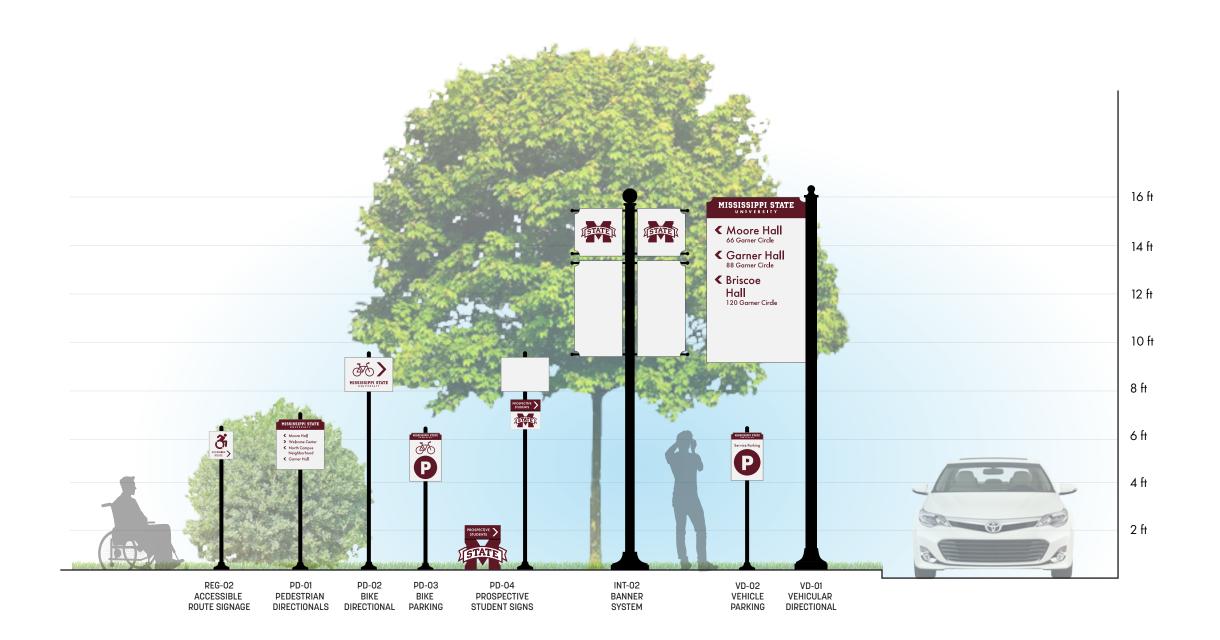
# PROJECT NAME

Mississippi State Univeristy Wayfinding and Signage Standards

# SHEET TITLE

Sign Type Family Overview

# SHEET NUMBER





DATE

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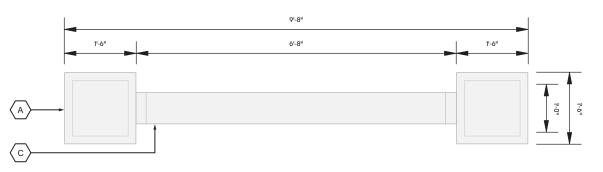
# PROJECT NAME

Mississippi State Univeristy Wayfinding and Signage Standards

# SHEET TITLE

Sign Type Family Overview

# SHEET NUMBER



BID-01 Neighborhood Gateway Top View



# BID-01 Neighborhood Gateway Double Stack



BID-01 Neighborhood Gateway Single Stack

Scale: 1/2" = 1'-0"



BID-01 Neighborhood Gateway Context Elevation

Scale: 1/2" = 1'-0"

LEGEND

A. CAST CONCRETE OR SLAB LIMESTONE COLUMN CAPS TO MATCH A CREAM/OFF WHITE COLOR. COLUMN BASES TO BE CAST CONCRETE OR LIMESTONE BUILT AROUND INTERNAL CINDER BLOCK STRUCTURE, TO MATCH CREAM/OFF WHITE.

B. BRICK MASONRY COLUMNS, BUILT AROUND INTERNAL CINDER BLOCK STRUCTURE, TO MATCH DESIGN LAYOUT TO EXISTING HISTORIC BRICK GATEWAY STRUCTURE. THE BRICK BOND IS INSET EVERY FORTH COURSE. BRICK MATERIAL/COLOR TO MATCH UNIVERSITY STANDARDS AS FOUND IN CAMPUS CLOCK TOWER CONSTRUCTION.

- C. CAST CONCRETE OR SLAB LIMESTONE WALL, BUILT AROUND INTERNAL STEEL FRAME STRUCTURE, TO MATCH CREAM/OFF WHITE COLOR. CONCRETE CAST TO GROUND.
- D. 1/2" THICK ALUMINUM DIMENSIONAL LETTERS PAINTED OR POWDER COATED TO MATCH PT.1 AS SHOWN. ALL PAINTED ELEMENTS TO RECEIVE A UV RATED AND WEATHER PROTECTION CLEAR COATING.
- E. 1/4" THICK ALUMINUM DIMENSIONAL LETTERS PAINTED OR POWDER COATED TO MATCH PT.1 AS SHOWN. ALL PAINTED ELEMENTS TO RECEIVE A UV RATED AND WEATHER PROTECTION CLEAR COATING.
- F. GRAPHICS ARE NOT TO EXCEED THE 4" BORDER SHOWN.
  STREET ADDRESSES ARE CENTER ALIGNED VERTICALLY 4"
  FROM THE BOTTOM OF THE CONCRETE FACE. DOUBLE LINE
  NAMES ARE CENTER ALIGNED VERTICALLY AND HORIZONTALLY
  IN REFERENCE TO THE CONCRETE FACE. TRIPLE LINE NAMES
  ARE VISUALLY ALIGNED TO HAVE A HIERARCHY SKEWED
  TOWARDS THE TOP EDGE OF THE BORDER.
- G. 1/4" THICK DECORATIVE BASEPLATE COVER. STUD MOUNTED TO CONCRETE SURFACE. PAINTED OR POWDER COATED TO MATCH PT.2 AS SHOWN. ALL PAINTED ELEMENTS TO RECEIVE A UV RATED AND WEATHER PROTECTION CLEAR COATING.

MISSISSIPPI STATE

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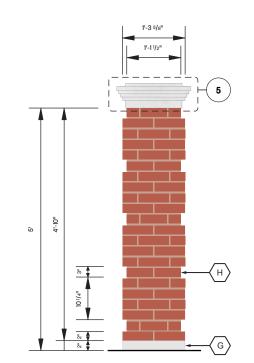
PROJECT NAME

Mississippi State Univeristy Wayfinding and Signage Standards

SHEET TITLE

BID-01 Neighborhood Gateway


SHEET NUMBER






1'-6"

1'-2"

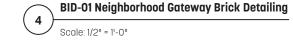

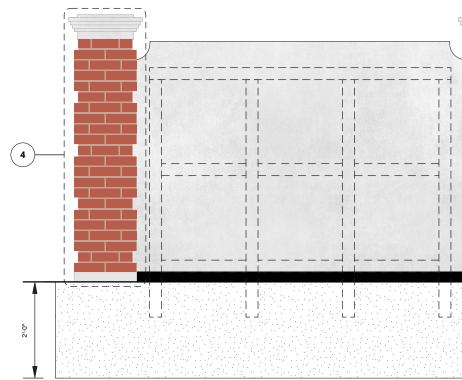



1'-3 5/8"

Scale: 1/2" = 1'-0"


**BID-01 Neighborhood Gateway Internal Infrastructure** 

Scale: 1/2" = 1'-0"

#### LEGEND

- A. FOUNDATION DETAILS TO BE CONFIRMED BY ENGINEER BASED ON FINAL DESIGN AND LOCATION.
- CAST CONCRETE OR SLAB LIMESTONE WALL, BUILT AROUND INTERNAL STEEL FRAME STRUCTURE. TO MATCH CREAM/OFF WHITE COLOR. CONCRETE CAST TO GROUND.
- C. 3" X 3" INTERNAL STEEL TUBING TO SUPPORT CAST IN PLACE CONCRETE WALL.
- D. 3" X 3" STEEL TUBING TO CONNECT TO BURIED FOUNDATION.
- E. BRICK COLUMN AND CAP BEYOND.
- F. 1/4" THICK DECORATIVE BASEPLATE COVER. STUD MOUNTED TO CONCRETE SURFACE. PAINTED OR POWDER COATED TO MATCH PT.2 AS SHOWN. ALL PAINTED ELEMENTS TO RECEIVE A UV RATED AND WEATHER PROTECTION CLEAR COATING.
- G. CAST CONCRETE OR SLAB LIMESTONE COLUMN CAPS TO MATCH A CREAM/OFF WHITE COLOR. COLUMN BASES TO BE CAST CONCRETE OR LIMESTONE, BUILT AROUND INTERNAL CINDER BLOCK STRUCTURE, TO MATCH CREAM/OFF WHITE COLOR.
- H. BRICK MASONRY COLUMNS, BUILT AROUND INTERNAL CINDER BLOCK STRUCTURE, TO MATCH DESIGN LAYOUT TO EXISTING HISTORIC BRICK GATEWAY STRUCTURE. THE BRICK BOND IS INSET EVERY FOURTH COURSE. BRICK MATERIAL AND COLOR TO MATCH UNIVERSITY STANDARDS AS FOUND IN CAMPUS CLOCK TOWER CONSTRUCTION.

\*ALL FOUNDATION DETAILS TO BE CONFIRMED BY ENGINEER BASED ON FINAL DESIGN AND LOCATION.\*

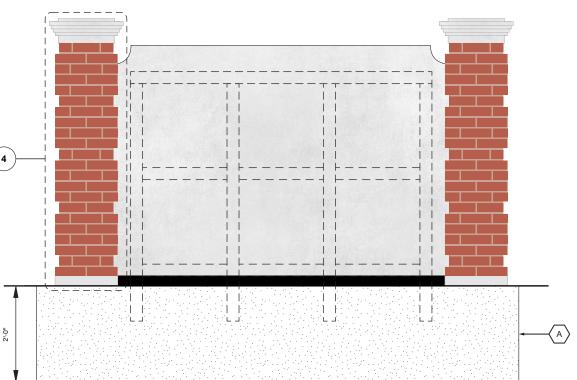

**BID-01 Neighborhood Gateway Foundation Detail** 

Scale: 1/2" = 1'-0"



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#### PROJECT NAME

Mississippi State Univeristy Wayfinding and Signage Standards

#### SHEET TITLE

BID-01 Neighborhood Gateway

#### SHEET NUMBER



BID-02 Ground Mounted Building ID Triple Stack

| Scale: 1/2" = 1'




BID-02 Ground Mounted Building ID Double Stack

| Scale: 1/2" = 1'



BID-02 Ground Mounted Building ID Single Stack

| Scale: 1/2" = 1'-0"

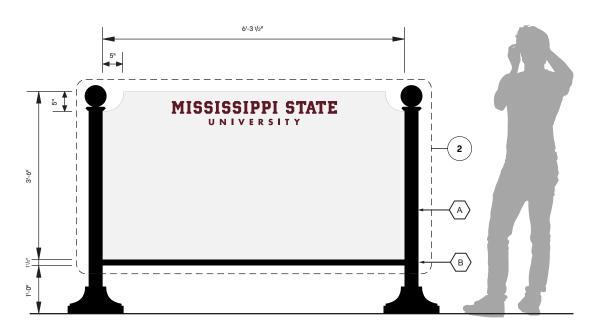

BID-02 Ground Mounted Building ID Context Elevation

Scale: 1/2" = 1'-0"

#### LEGEND

- A. EXISTING POST FOR REFERENCE. 3 1/2" DIAMETER WITH BOLLARD CAP AND BASE CAP. SEE NEXT PAGE FOR MORE DETAILS.
- EXISTING C-CHANNEL. 4" X 1-1/2" X 3/16" MOUNTED AND SPANNING BETWEEN TWO EXISTING VERTICAL POSTS.
   PAINTED TO MATCH HIGH GLOSS INDUSTRIAL BLACK (2 COATS).
- C. 2" THICK FABRICATED ALUMINUM SIGNAGE CABINET.

  COVE EDGE DETAILING ON CABINET TOP. FABRICATED CABINET

  WILL HAVE INTERNAL STRUCTURE AS NEEDED WITH HIDDEN

  FASTENERS. ALL EXPOSED WELDS TO BE GROUND AND

  SMOOTHED. CABINET PAINTED OR POWDER COATED TO MATCH

  PT.1 AND PT.5 AS SHOWN. ALL PAINTED ELEMENTS TO RECEIVE

  A UV RATED AND WEATHER PROTECTION CLEAR COATING.
- SURFACE APPLIED VINYL MESSAGES TO MATCH V.1 AS SHOWN. FINISHED WITH A UV PROTECTION LAMINATE.
- E. GRAPHICS ARE NOT TO EXCEED THE 2" BORDER SHOWN. STREET ADDRESSES ARE CENTER ALIGNED VERTICALLY 2" FROM THE BOTTOM OF THE CONCRETE FACE. SINGLE LINE NAMES ARE CENTER ALIGNED VERTICALLY AND HORIZONTALLY IN REFERENCE TO THE CONCRETE FACE. DOUBLE AND TRIPLE LINE NAMES ARE VISUALLY ALIGNED TO HAVE A HIERARCHY SKEWED TOWARDS THE TOP EDGE OF THE BORDER.



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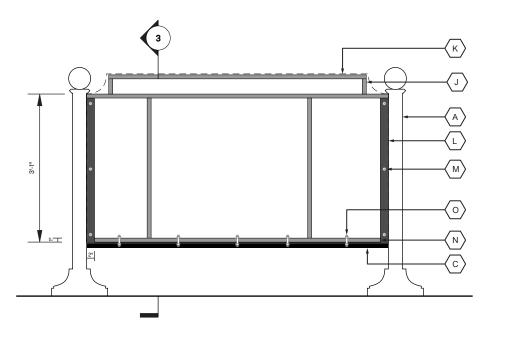


Mississippi State Univeristy Wayfinding and Signage Standards

#### SHEET TITLE


BID-02 Ground Mounted Building ID

SHEET NUMBER




BID-02 Ground Mounted Building ID Cabinet Attachment Detail

Scale: 1/2" = 1'-0"

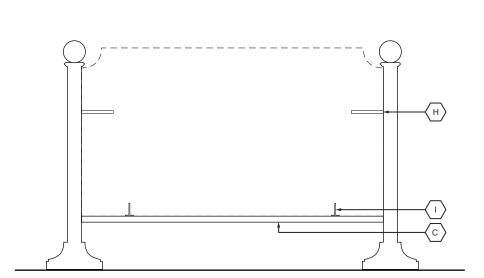


BID-02 Ground Mounted Building ID Existing Signage Structure

Scale: 1/2" = 1'-0"

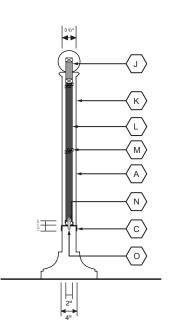

**BID-02 Ground Mounted Building ID Cabinet Section** 

Scale: 1/2" = 1'-0"

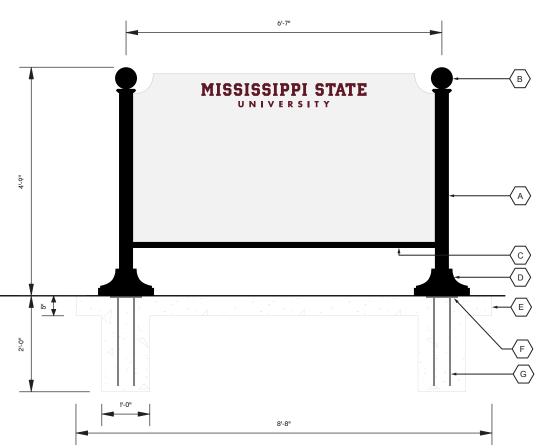

**BID-02 Ground Mounted Building ID Existing Foundation Detail** 

Scale: 1/2" = 1'

#### LEGEND

- ROBINSON IRON OF ALABAMA PAINTED TO MATCH HIGH GLOSS INDUSTRIAL BLACK (2 COATS).
- C. EXISTING C-CHANNEL. 4" X 1-1/2" X 3/16" MOUNTED AND
- D. 14-1/4" X 14-1/4" MSU STANDARD SIGN BASE BY: ROBINSON IRON OF ALABAMA. PAINTED TO MATCH HIGH GLOSS
- E. EXISTING CONCRETE FOUNDATION FOR REFERENCE.
- F. EXISTING METAL FOUNDATION PLATE FOR REFERENCE. 8" X 8" X 3/8" PLATE WELD (4) 18" NO.4 REBAR TO PLATE WELD
- G. EXISTING 1/2" REBAR.

- SIGN CABINET ATTACHED TO TUBE MOUNTING STRUCTURE WITH MECHANICAL FASTENERS ON CABINET FACE. ALL FASTENERS PAINTED TO MATCH ADJACENT CABINET FACE. COUNTERSUNK FOR SEAMLESS LOOK. ALL PAINTED ELEMENTS TO RECEIVE A UV RATED AND WEATHER PROTECTION CLEAR
- N. BLOCKING BASE FOR ANCHOR BOLT REINFORCEMENT.
- ANCHOR BOLTS TO SECURE SIGN CABINET. HIDDEN WITHING



DATE

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Mississippi State Univeristy Wayfinding and Signage Standards

SHEET TITLE

BID-02 Ground Mounted Building ID

SHEET NUMBER

15



SPANNING BETWEEN TWO EXISTING VERTICAL POSTS.

INDUSTRIAL BLACK (2 COATS).

3500 PSI CONCRETE LIGHT BROOM FINISH 1/2" TOOLED EDGE.

3-1/2" SIGN POST TO 8" X 8" PLATE.

EXISTING 5/8" STEEL ROD TO BE REMOVED.

EXISTING WELDED ANCHORS TO BE REMOVED.

INTERNAL SIGNAGE CABINET INFRASTRUCTURE AS NEEDED.

2" THICK NEW SIGNAGE CABINET.

NEW 1-7/8" X 1-7/8" TUBE MOUNTING STRUCTURE WELDED TO EXISTING POST TO SUPPORT CABINET MOUNTING.

SIGNAGE AND UNDER C-CHANNEL.



WATER JET-CUT ALUMINUM LETTERS, PAINTED OR POWDER COATED TO MATCH PT-6 AS SHOWN. ALL PAINTED ELEMENTS TO RECEIVE A UV RATED AND WEATHER PROTECTION CLEAR COATING.

# COLVARD STUDENT UNION

WATER JET-CUT ALUMINUM LETTERS, PAINTED OR POWDER COATED TO MATCH PT.3 AS SHOWN. ALL PAINTED ELEMENTS TO RECEIVE A UV RATED AND WEATHER PROTECTION CLEAR COATING.

# COLVARD STUDENT UNION

WATER JET-CUT ALUMINUM LETTERS, PAINTED OR POWDER COATED TO MATCH PT.2 AS SHOWN. ALL PAINTED ELEMENTS TO RECEIVE A UV RATED AND WEATHER PROTECTION CLEAR COATING.

# COLVARD STUDENT UNION

LETTERS ETCHED OR SANDBLASTED INTO STONE OR AGGREGATE FACADE MATERIAL. LETTERS INFILLED WITH PAINT OR POWDER COATED TO MATCH PT.2 AS SHOWN. ALL PAINTED ELEMENTS TO RECEIVE A UV RATED AND WEATHER PROTECTION CLEAR COATING.



WATER JET-CUT ALUMINUM LETTERS WITH #4 HORIZONTAL GRAIN FINISH

4

**BID-03 Color and Material Options** 

Scale: NTS

# LETTER CLEARANCE





3

**BID-03 Single Line Surface Mounted Building ID** 

Scale: NTS

# LETTER CLEARANCE

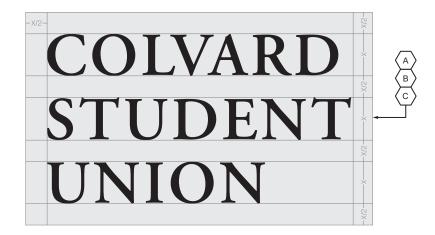

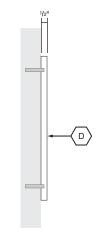

(<u>2</u>)

BID-03 Multi-Line Surface Mounted Building ID

Scale: NTS



Scale: 1-1/2" = 1'-0"

#### LEGEND

- A. FONT IS ADOBE GARAMOND PRO SEMI-BOLD. TYPE SET WITH 50 PT LETTER SPACING.
- B. THE CAP HEIGHT OF THE LETTERS MUST BE BETWEEN 8" AND 12". PROPOSED HEIGHTS OUTSIDE OF THE RANGE MUST BE APPROVED BY CAMPUS SERVICES. LETTERS MUST BE MOUNTED AT LEAST HALF OF THE CAP HEIGHT DISTANCE FROM THE EDGE OF THE ENTRY DOOR OR DETAILING.
- C. SINGLE LINE IS PREFERRED WHEN SPACE ALLOWS. STACK LEFT WHEN SPACE IS LIMITED. WHEN LEFT ALIGNED, LINE SPACING TO BE HALF THE CAP HEIGHT.
- D. LETTERS TO BE MOUNTED ABOVE PRIMARY BUILDING ENTRY UNLESS ARCHITECTURAL FEATURES OBSTRUCT MOUNTING. LETTER CLEARANCE MUST ABIDE BY ESTABLISHED GRAPHIC STANDARDS SHOWN. LETTERS TO BE 1/2" THICK.
- E. MATERIALS AND FINISH TO CONTRAST WITH THE FINISH TO THE WALL SURFACE IT IS BEING APPLIED TO. SELECTION OF THE FINISH IS AT THE DISCRETION OF THE ARCHITECT BUT MUST BE SELECTED FROM THE PROVIDED LIST, UNLESS APPROVED BY CAMPUS SERVICES.



DATE

February 17, 2023

#### NOTE

It is the intent of these guidelines that all new buildings at MSU will include Building Mounted Identification Signage.

Location and placement shall be informed by the building's architectural elements.




Mississippi State Univeristy Wayfinding and Signage Standards

#### SHEET TITLE

BID-03 Wall Mounted Building ID

SHEET NUMBER

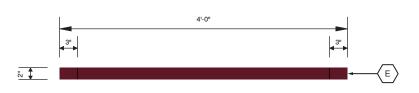



4'-0"


3'-6"

DIR-01 Insert Directory Top View

Scole: 3/4" = 1!-O"

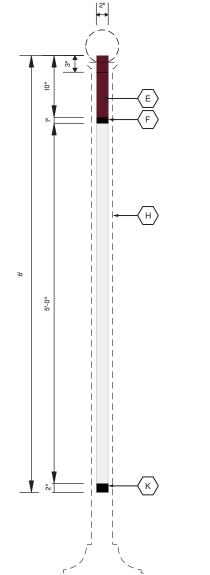

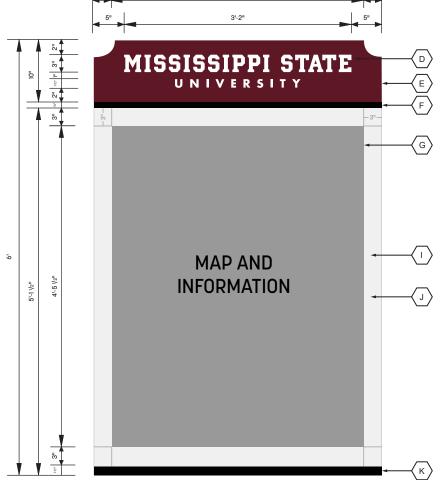

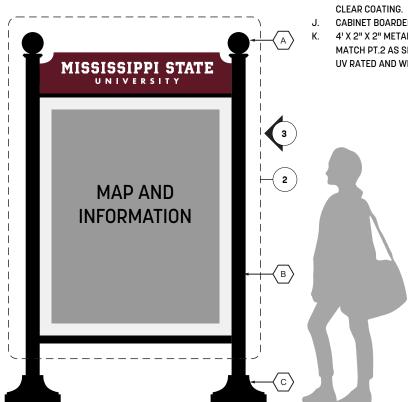

# DIR-01 Insert Directory Side View

Scale: 3/4" = 1'-0"

2 DIR-01 Insert Directory Detail
Scale: 3/4" = 1'-0"

# DIR-01 Insert Directory Context Elevation | Scale: 1/2" = 1'-0"

#### LEGEND

- A. 5-1/2" BOLLARD CAP BY: ROBINSON IRON OF ALABAMA PAINTED TO MATCH HIGH GLOSS INDUSTRIAL BLACK (2 COATS).
- B. 3-1/2" SCHEDULE 40 PIPE PAINTED TO MATCH HIGH GLOSS INDUSTRIAL BLACK (2 COATS).
- C. 14-1/4" X 14-1/4" MSU STANDARD SIGN BASE BY: ROBINSON IRON OF ALABAMA. PAINTED TO MATCH HIGH GLOSS INDUSTRIAL BLACK (2 COATS).
- D. SURFACE APPLIED VINYL MESSAGES TO MATCH V.3 AS SHOWN. FINISHED WITH A UV PROTECTION LAMINATE.
- E. 2" THICK FABRICATED ALUMINUM SIGNAGE CABINET. COVE EDGE DETAILING ON CABINET TOP. FABRICATED CABINET WILL HAVE INTERNAL STRUCTURE AS NEEDED WITH HIDDEN FASTENERS. ALL EXPOSED WELDS TO BE SMOOTHED. CABINET PAINTED OR POWDER COATED TO MATCH PT.5 AS SHOWN. ALL PAINTED ELEMENTS TO RECEIVE A UV RATED AND WEATHER PROTECTION CLEAR COATING.
- F. 4' X 1" X 2" METAL TUBE PAINTED OR POWDER COATED TO MATCH PT.2 AS SHOWN. ALL PAINTED ELEMENTS TO RECEIVE UV RATED AND WEATHER PROTECTION CLEAR COATING. INTERNALLY FASTENED TO VERTICAL SUPPORT STRUCTURE. FLUSH WITH SIGNAGE CABINET FACE.
- G. MAP GRAPHIC INSERT. DOUBLE SIDED.
- H. 1/4" THICK ALUMINUM CABINET FACE PAINTED OR POWDER COATED TO MATCH PT.5 AS SHOWN. ALL PAINTED ELEMENTS TO RECEIVE UV RATED AND WEATHER PROTECTION CLEAR COATING.
- . 2" THICK FABRICATED ALUMINUM SIGNAGE CABINET.
  REMOVABLE. WILL HAVE INTERNAL STRUCTURE AS NEEDED
  WITH TAMPER RESISTANT SCREWS ON CABINET FACE. PAINTED
  OR POWDER COATED TO MATCH P.1 AS SHOWN. ALL PAINTED
  ELEMENTS TO RECEIVE UV RATED AND WEATHER PROTECTION
  CLEAR COATING
- J. CABINET BOARDER TO MAINTAIN 3" CLEARANCE.
- (. 4' X 2" X 2" METAL TUBE PAINTED OR POWDER COATED TO MATCH PT.2 AS SHOWN. ALL PAINTED ELEMENTS TO RECEIVE UV RATED AND WEATHER PROTECTION CLEAR COATING.

#### PROJECT NAME

Mississippi State Univeristy Wayfinding and Signage Standards

#### SHEET TITLE

DIR-01 Insert Directory Layout Details

#### SHEET NUMBER

17



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or the mentioned client. No part of this drawing,

design, or arrangement shall be duplicated or used

for any purpose without the express written permission

mentioned project, and remain the property of Sasaki

prior to fabrication. Contractors shall be responsible

DATE

NOTE


February 17, 2023

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\*ALL FOUNDATION DETAILS TO BE CONFIRMED BY ENGINEER BASED ON FINAL DESIGN AND LOCATION.\*

#### LEGEND

- A. 5-1/2" BOLLARD CAP BY: ROBINSON IRON OF ALABAMA PAINTED TO MATCH HIGH GLOSS INDUSTRIAL BLACK (2 COATS).
- B. 4' X 1" X 2" METAL TUBE WELDED TO TWO VERTICAL POSTS, SANDED AND GROUND SMOOTH. PAINTED TO MATCH HIGH GLOSS INDUSTRIAL BLACK (2 COATS).
- C. 3-1/2" SCHEDULE 40 PIPE PAINTED TO MATCH HIGH GLOSS INDUSTRIAL BLACK (2 COATS).
- D. 4' X 1" X 2" METAL TUBE WELDED TO TWO VERTICAL POSTS, SANDED AND GROUND SMOOTH. PAINTED TO MATCH HIGH GLOSS INDUSTRIAL BLACK (2 COATS).
- E. 14-1/4" X 14-1/4" MSU STANDARD SIGN BASE BY: ROBINSON IRON OF ALABAMA. PAINTED TO MATCH HIGH GLOSS INDUSTRIAL BLACK (2 COATS).
- F. 3-1/2" STEEL POST.
- G. 1'-6" CONCRETE FOOTING.
- H. 2" THICK SIGNAGE CABINET.
- I. 1" X 1-1/2" INTERNAL TUBE MOUNTING STRUCTURE WELDED TO VERTICAL POSTS AND HORIZONTAL FRAMEWORK TO SUPPORT CABINET MOUNTING. SANDED AND GROUND SMOOTH.
- J. 1" X 1-1/2" INTERNAL TUBE MOUNTING STRUCTURE WELDED TO VERTICAL POSTS AND HORIZONTAL FRAMEWORK. SANDED AND GROUND SMOOTH.
- K. MAP GRAPHIC SIGNAGE CABINET ATTACHED TO TUBE
  MOUNTING STRUCTURE WITH 1/2" THICK TAMPER RESISTANT
  SCREWS ON FRAME FACE. FASTENERS PAINTED TO MATCH
  ADJACENT FRAME FACE. COUNTERSUNK FOR SEAMLESS LOOK.
- .. 1/4" THICK ALUMINUM FRAME PAINTED TO MATCH PT.5.
  DOUBLE SIDED.
- M. 1/8" THICK NON-GLARE CLEAR ACRYLIC. DOUBLE SIDED.
- . 1/8" THICK ACRYLIC BACKER. DOUBLE SIDED.
- 1/4" THICK ALUMINUM FRAME PAINTED TO MATCH PT.1. DOUBLE SIDED.
- P. ALL SEAMS AROUND REMOVABLE SIGNAGE ELEMENTS TO RECEIVE GASKET, OR SIMILAR WATER LEAK PREVENTION METHOD.
- Q. SPACER.
- R. MAP GRAPHIC INSERT.



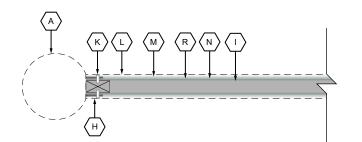


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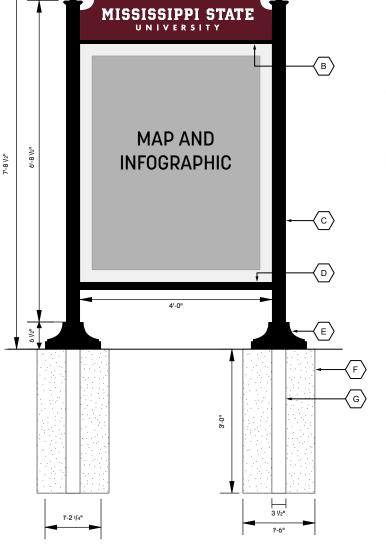
**DIR-01 Insert Directory Cabinet Section** 

Scale: 1/2" = 1'-0"



DIR-01 Insert Directory Cabinet Attachment Detail

Scale: 1/2" = 1'-0"

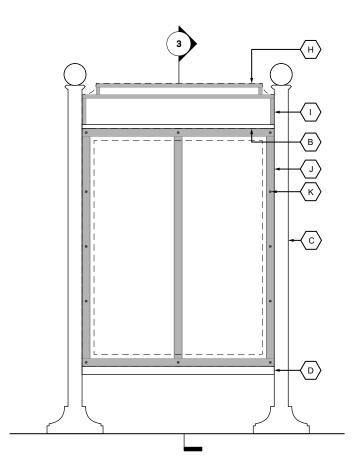

DIR-01 Insert Directory Foundation Detail

Scale: 1/2" = 1'-0"



DATE

February 17, 2023

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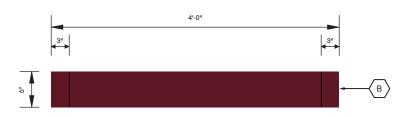
#### PROJECT NAME

Mississippi State Univeristy Wayfinding and Signage Standards


#### SHEET TITLE


DIR-01 Insert Directory Building Details

SHEET NUMBER



**DIR-02 Digital Directory Top View** 

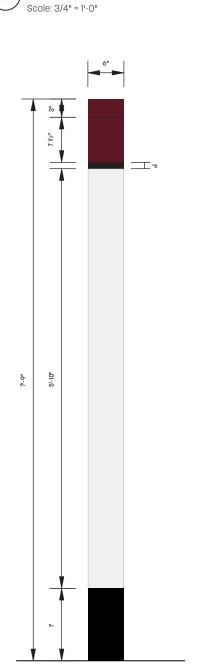

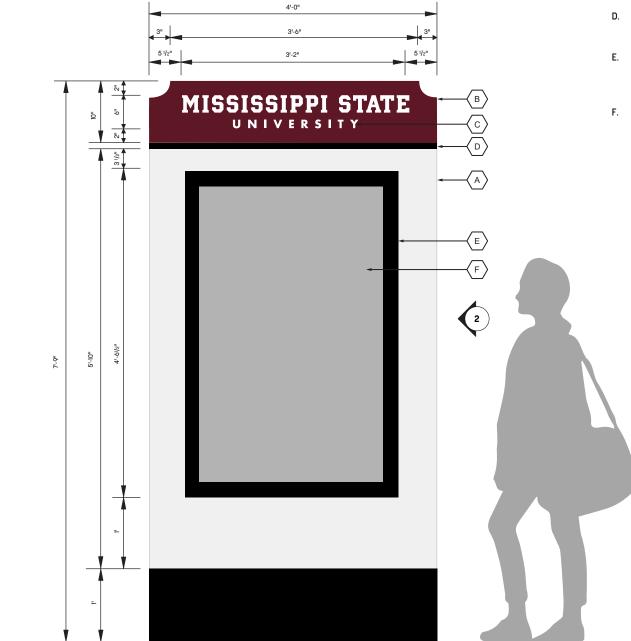

**DIR-02 Digital Directory Side View** 

Scale: 3/4" = 1'-0"

DIR-02 Digital Directory Context Elevation and Detail Scale: 3/4" = 1'-0"

#### LEGEND

- A. 6" THICK FABRICATED ALUMINUM SIGNAGE CABINET. WILL HAVE INTERNAL STRUCTURES AS NEEDED WITH TAMPER RESISTANT SCREWS AND STUD MOUNTING ON CABINET FACE. PAINTED OR POWDER COATED TO MATCH PT.2 AND PT.5 AS SHOWN. ALL PAINTED ELEMENTS TO RECEIVE UV RATED AND WEATHER PROTECTION COATING.
- B. 6" THICK FABRICATED ALUMINUM SIGNAGE CABINET. COVE EDGE DETAILING ON CABINET TOP. FABRICATED CABINET WILL HAVE INTERNAL STRUCTURE AS NEEDED WITH HIDDEN FASTENERS. ALL EXPOSED WELDS TO BE SMOOTHED. CABINET PAINTED OR POWDER COATED TO MATCH PT.5 AS SHOWN. ALL PAINTED ELEMENTS TO RECEIVE A UV RATED AND WEATHER PROTECTION CLEAR COATING.
- SURFACE APPLIED VINYL MESSAGES TO MATCH V.1 AS SHOWN. FINISHED WITH A UV PROTECTION LAMINATE.
- D. 4' X 1" X 5-1/2" METAL TUBE PAINTED OR POWDER COATED TO MATCH PT.2 AS SHOWN. ALL PAINTED ELEMENTS TO RECEIVE A UV RATED AND WEATHER PROTECTION CLEAR COATING.
- E. ALUMINUM DISPLAY FRAME COVER PAINTED OR POWDER COATED TO MATCH PT.2 AS SHOWN. ALL PAINTED ELEMENTS TO RECEIVE A UV RATED AND WEATHER PROTECTION CLEAR COATING.
- 58" DIGITAL DISPLAY. DISPLAY SYSTEM TO BE SELECTED BY MSU. CONTENT TO BE PROVIDED BY MSU.



DATE

February 17, 2023

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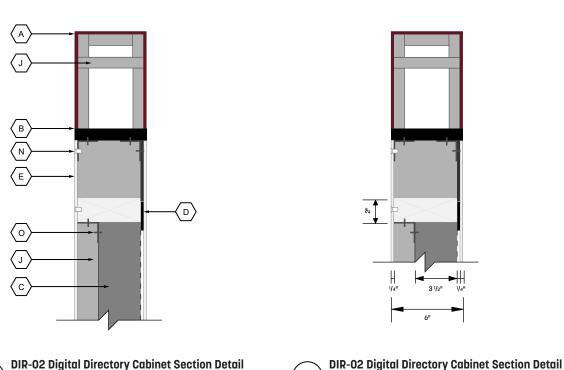


Mississippi State Univeristy Wayfinding and Signage Standards


#### SHEET TITLE

DIR-02 Digital Directory Layout Details

SHEET NUMBER



\*ALL FOUNDATION DETAILS TO BE CONFIRMED BY ENGINEER BASED ON FINAL DESIGN AND LOCATION.\*

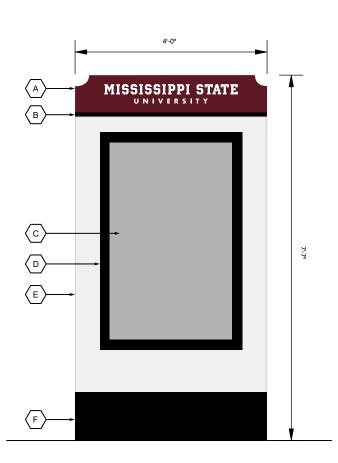

LEGEND

- A. 1/4" THICK ALUMINUM SIGNAGE CABINET FACING PAINTED OR POWDER COATED TO MATCH PT.1 AS SHOWN, ALL PAINTED **ELEMENTS TO RECEIVE A UV RATED AND WEATHER PROTECTION**
- B. 4' X 1" X 5-1/2" METAL TUBE WELDED TO VERTICAL POSTS THEN SANDED AND GROUND SMOOTH. PAINTED OR POWDER COATED TO MATCH PT.2 AS SHOWN. ALL PAINTED ELEMENTS TO RECEIVE A UV RATED AND WEATHER PROTECTION CLEAR COATING.
- 58" DIGITAL DISPLAY. C.
- 1/4" THICK ALUMINUM DISPLAY FRAME COVER PAINTED OR D. POWDER COATED TO MATCH PT.2 AS SHOWN. WELDED OR MECHANICALLY FASTENED TO INTERNAL TUBE STRUCTURE ON SIGNAGE CABINET INTERIOR. ALL PAINTED ELEMENTS TO RECEIVE A UV RATED AND WEATHER PROTECTION CLEAR COATING.
- E. 1/4" THICK ALUMINUM SIGNAGE CABINET FACING PAINTED OR POWDER COATED TO MATCH PT.5 AS SHOWN. ALL PAINTED ELEMENTS TO RECEIVE A UV RATED AND WEATHER PROTECTION CLEAR COATING.
- F. 1/4" THICK ALUMINUM SIGNAGE CABINET BASE FACING PAINTED OR POWDER COATED TO MATCH PT.2 AS SHOWN. WELDED OR MECHANICALLY FASTENED TO INTERNAL TUBE STRUCTURE ON SIGNAGE CABINET INTERIOR. ALL PAINTED ELEMENTS TO RECEIVE A UV RATED AND WEATHER PROTECTION CLEAR COATING.
- 1'-6" CONCRETE FOOTING.
- 4" X 6" STEEL POST.
- 6" THICK SIGNAGE CABINET.
- 1" X 1" INTERNAL TUBE MOUNTING STRUCTURE WELDED TO VERTICAL POSTS AND HORIZONTAL FRAMEWORK TO SUPPORT CABINET MOUNTING.
- K. 1" X 5-1/2" INTERNAL TUBE MOUNTING STRUCTURE WELDED FRAMEWORK TO SUPPORT CABINET MOUNTING.
- 2" X 5-1/2" INTERNAL TUBE MOUNTING STRUCTURE WELDED FRAMEWORK TO SUPPORT CABINET MOUNTING.
- SEALED POWER SOURCE ACCESS. TO BE SPECIFIED BY ELECTRICIAN. POWER TO BE ACCESSED THROUGH THE GROUND.
- BACK FACE OF CABINET REMOVABLE FOR DIGITAL DISPLAY MAINTENANCE. CABINET FACE ATTACHED TO INTERNAL MOUNTING WITH TAMPER RESISTANT SCREWS.
- DIGITAL DISPLAY FRAME ATTACHED TO TUBE MOUNTING STRUCTURE WITH L-BRACKETS. 2-1/2" OF OPEN SPACE BEHIND DISPLAY FOR VENTILATION AND AIR FLOW.



DATE

February 17, 2023

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#### PROJECT NAME

Mississippi State Univeristy Wayfinding and Signage Standards

#### SHEET TITLE

DIR-02 Digital Directory **Building Details** 

SHEET NUMBER

20




Scale: 1/2" = 1'-0"

Scale: 1-1/2" = 1'-0"

**DIR-02 Digital Directory Cabinet Attachment** 

Scale: 1-1/2" = 1'-0"


**DIR-02 Digital Directory Foundation Details** Scale: 1/2" = 1'-0"

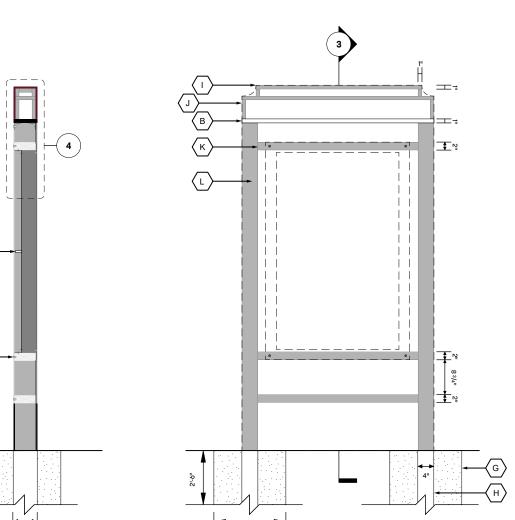


1'-6"

# ў-О<sup>н</sup>

# INT-01 Interpretive Sign Top View Scale: 3" = 1'-0"

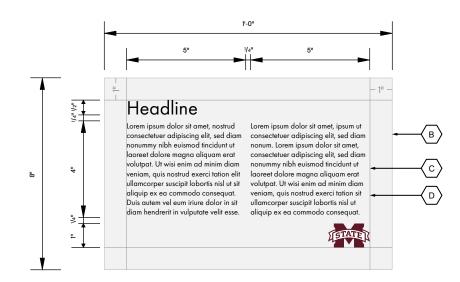



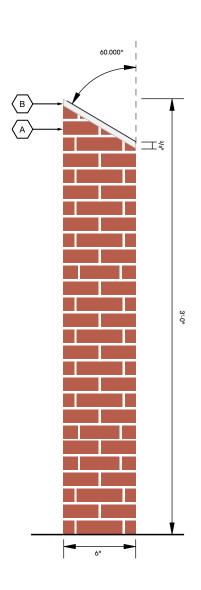


2 INT-01 Interpretive Sign Side View

Scale: 1-1/2" = 1'-0"

#### LEGEND

- A. BRICK MASONRY COLUMN. BRICK MATERIAL/COLOR TO MATCH UNIVERSITY STANDARDS AS FOUND IN CAMPUS CLOCK TOWER CONSTRUCTION. TOP CUT AT A 60° ANGLE.
- B. 3/8" THICK ALUMINUM PANEL PAINTED OR POWDER COATED TO MATCH PT.5 AS SHOWN. ALL PAINTED ELEMENTS TO RECEIVE A UV RATED AND WEATHER PROTECTION CLEAR COATING.
- C. SURFACE APPLIED VINYL MESSAGES TO MATCH V.2 AS SHOWN. FINISHED WITH A UV PROTECTION LAMINATE.
- D. TEXT AND GRAPHICS NOT TO EXCEED THE 1" BORDER SHOWN. MUST BE AT LEAST 1/4" BETWEEN LAST LINE OF TEXT AND MISSISSIPPI STATE UNIVERSITY LOGO.

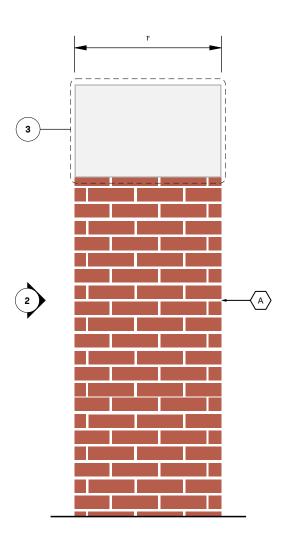

1 INT-01 Interpretive Sign Context Elevation

Scale: 1-1/2" = 1'-0"



DATE

February 17, 2023

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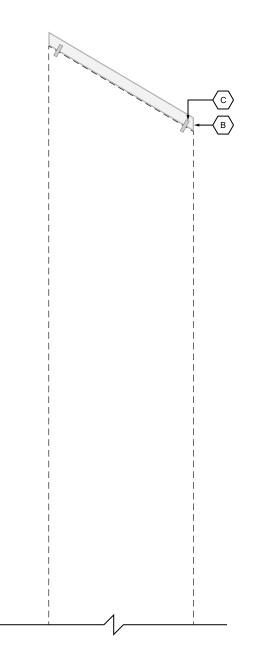
PROJECT NAME


Mississippi State Univeristy Wayfinding and Signage Standards

SHEET TITLE

INT-01 Interpretive Sign Layout Details

SHEET NUMBER



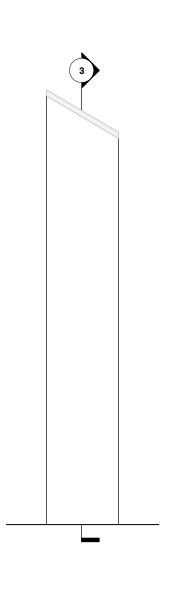





# 1) INT-01 Interpretive Sign Context Elevation | Scale: 1-1/2" = 1'-0"

#### LEGEND



- B. BRICK MASONRY COLUMN. BRICK MATERIAL/COLOR TO MATCH UNIVERSITY STANDARDS AS FOUND IN CAMPUS CLOCK TOWER CONSTRUCTION. TOP CUT AT A 60° ANGLE.
- C. CONCRETE FOUNDATION. 3500 PSI CONCRETE LIGHT BROOM FINISH 1/2" TOOLED EDGE.
- D. PANEL STUD MOUNTED INTO BRICK MASONRY WITH NO VISIBLE FASTENERS ON PANEL FACE.

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DATE

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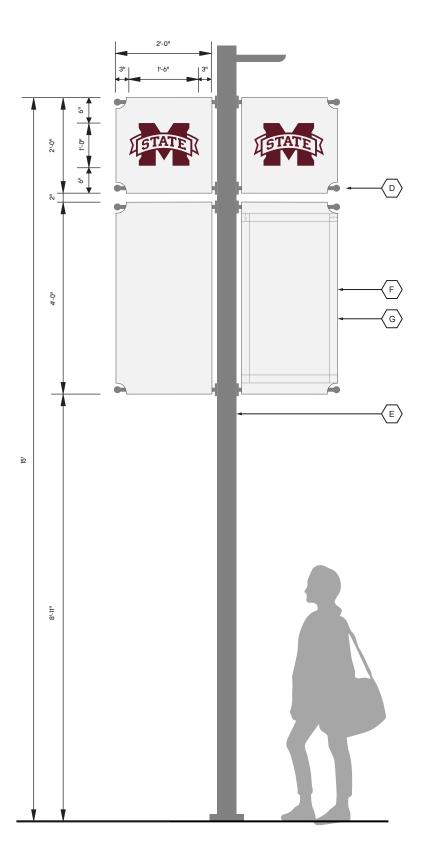


Mississippi State Univeristy Wayfinding and Signage Standards


# SHEET TITLE

INT-01 Interpretive Sign Building Details

SHEET NUMBER





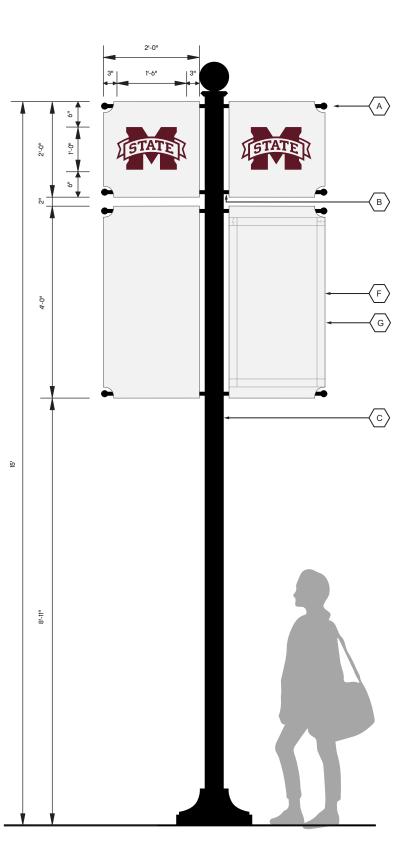

INT-02 Welded Banner System Context Elevation

Scale: 1/2" = 1'-0"

LEGEND

- A. 1-3/4" REMOVABLE DECORATIVE BALL CAP FINIALS TO MATCH METALCRAFT'S BANNER BRACKET BALL FINIALS IN THE COLOR BLACK OR SIMILAR. PRODUCT AVAILABLE HERE: https://metalcraftindustries.net/banner-bracket-decorative-b all-finial-caps-pair/
- B. 1" STAINLESS STEEL TUBES WELDED TO EXISTING LIGHT POSTS. WELDS GROUND AND SMOOTHED. PAINTED OR POWDER COATED TO MATCH PT.2 AS SHOWN. ENDS TREADED TO RECEIVE FINIAL STOPPER. ALL PAINTED ELEMENTS TO RECEIVE A UV RATED AND WEATHER PROTECTION CLEAR COATING.
- C. EXISTING POLE FOR REFERENCE.
- BANNERS ATTACHED TO POST USING SIGN BRACKET STORE'S
  "TWO-WAY BALL FINIAL BANNER" SYSTEM OR SIMILAR. ALL
  ELEMENTS PAINTED OR POWDER COATED TO MATCH THE
  EXISTING POST. POST SIZE TO BE VERIFIED IN FIELD. ALL
  PAINTED ELEMENTS TO RECEIVE A UV RATED AND WEATHER
  PROTECTION CLEAR COATING. PRODUCT AVAILABLE HERE:
  https://www.signbracketstore.com/banner-brackets/banner-brackets-ball.html
- E. EXISTING POLE FOR REFERENCE.
- F. 13 OUNCE VINYL BANNER FABRIC WITH SEWN COVE EDGE DETAIL. PRINTED CUSTOM. FINAL IMAGERY AND CONTENT TO BE DETERMINED BY MSU.
- G. TEXT AND GRAPHICS NOT TO EXCEED THE 2" BORDER SHOWN.



DATE

February 17, 2023

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Mississippi State Univeristy Wayfinding and Signage Standards


# SHEET TITLE

INT-02 Banner System Layout Details

SHEET NUMBER

# LEGEND

- A. 2" DOME CAP TO MATCH HIGH GLOSS INDUSTRIAL BLACK (2 COATS).
- B. 2" SCHEDULE 40 PIPE PAINTED TO MATCH HIGH GLOSS INDUSTRIAL BLACK (2 COATS).
- C. 8" X 8" SIGN BASE BY: ROBINSON IRON OF ALABAMA.
  PAINTED TO MATCH HIGH GLOSS INDUSTRIAL BLACK (2 COATS)
- D. SURFACE APPLIED VINYL MESSAGES TO MATCH V.3 AS SHOWN. FINISHED WITH A UV PROTECTION LAMINATE.
- E. 1/4" THICK ALUMINUM PANEL PAINTED OR POWDER COATED TO MATCH PT.1 AND PT.5 AS SHOWN. ALL PAINTED ELEMENTS TO RECEIVE A UV RATED AND WEATHER PROTECTION CLEAR COATING
- F. SURFACE APPLIED VINYL MESSAGES TO MATCH V.1 AS SHOWN. FINISHED WITH A UV PROTECTION LAMINATE.
- G. GRAPHICS ARE NOT TO EXCEED THE 2" BORDER SHOWN.
  TEXT TO BE TYPESET AS SHOWN. ALIGN TOP LINE TO THE 2"
  BORDER, THEN CENTER ALIGN ALL INFORMATION
  HORIZONTALLY WITHIN THE 1" BORDER.
- H. 3/8" X 1" METAL FRAMEWORK SYSTEM. FIXED TO PANEL WITH ADHESION AND FASTENERS AS REQUIRED. NO FASTENERS ON THE PANEL FACE.

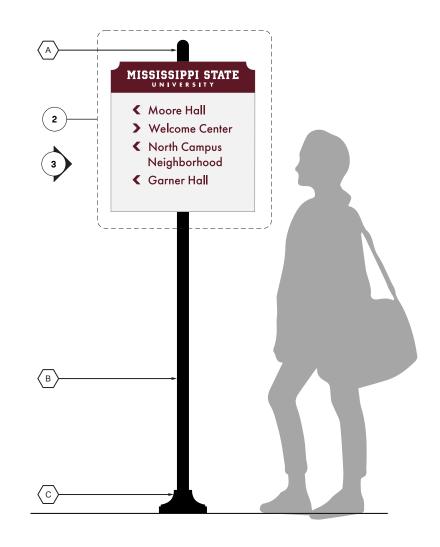













DATE

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Mississippi State Univeristy Wayfinding and Signage Standards

#### SHEET TITLE


PD-01 Pedestrian Directional Layout Details


SHEET NUMBER

\*ALL FOUNDATION DETAILS TO BE CONFIRMED BY ENGINEER BASED ON FINAL DESIGN AND LOCATION.\*

#### LEGEND

- A. 2" DOME CAP TO MATCH HIGH GLOSS INDUSTRIAL BLACK (2 COATS).
- B. 2" SCHEDULE 40 PIPE PAINTED TO MATCH HIGH GLOSS INDUSTRIAL BLACK (2 COATS).
- C. 8" X 8" SIGN BASE BY: ROBINSON IRON OF ALABAMA.
  PAINTED TO MATCH HIGH GLOSS INDUSTRIAL BLACK (2 COATS)
- D. 2" STEEL POST.
- E. 8" CONCRETE FOOTING.
- F. 1/4" THICK ALUMINUM PANEL PAINTED OR POWDER COATED TO MATCH PT.1 AND PT.5 AS SHOWN. ALL PAINTED ELEMENTS TO RECEIVE A UV RATED AND WEATHER PROTECTION CLEAR COATING
- G. 3/8" X 1" METAL FRAMEWORK SYSTEM. FIXED TO PANEL WITH ADHESION AND FASTENERS AS REQUIRED. NO FASTENERS ON THE PANEL FACE. FRAMEWORK PAINTED TO MATCH ADJACENT PANEL FACE COLORS.
- H. BACKER FRAME TO BE WELDED TO EXISTING POST. WELDS GROUND AND SMOOTHED.

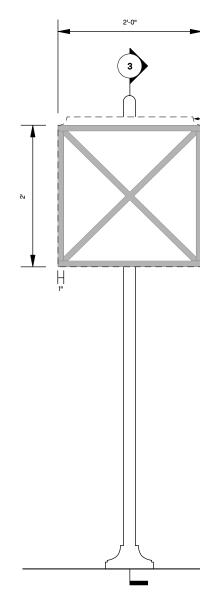

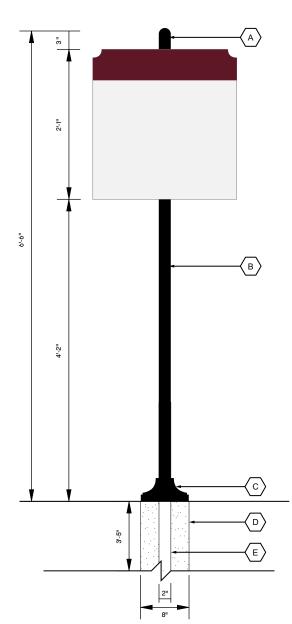



PD-01 Pedestrian Directional Section Detail

PD-01 Pedestrian Directional Top View

Scale: 3/4" = 1'-0"

▼ PD-01 Pedestrian Directional Section

PD-01 Pedestrian Directional Attachment Detail

Scale: 3/4" = 1'-0"



PD-01 Pedestrian Directional Foundation Detail

Scale: 3/4" = 1'-0"



DATE

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# PROJECT NAME

Mississippi State Univeristy Wayfinding and Signage Standards

#### SHEET TITLE

PD-01 Pedestrian Directional Building Details

SHEET NUMBER

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#### LEGEND


- A. 2" DOME CAP TO MATCH HIGH GLOSS INDUSTRIAL BLACK (2 COATS).
- B. 2" SCHEDULE 40 PIPE PAINTED TO MATCH HIGH GLOSS INDUSTRIAL BLACK (2 COATS).
- C. 8" X 8" SIGN BASE BY: ROBINSON IRON OF ALABAMA. PAINTED TO MATCH HIGH GLOSS INDUSTRIAL BLACK (2 COATS)
- D. SURFACE APPLIED VINYL MESSAGES TO MATCH V.1 AS SHOWN. FINISHED WITH A UV PROTECTION LAMINATE.
- E. 1/4" THICK ALUMINUM PANEL PAINTED OR POWDER COATED TO MATCH P.5 AS SHOWN. ALL PAINTED ELEMENTS TO RECEIVE A UV RATED AND WEATHER PROTECTION CLEAR COATING.
- F. GRAPHICS ARE NOT TO EXCEED THE 1" BORDER SHOWN. TEXT TO BE TYPESET AS SHOWN, THEN CENTER ALIGNED VERTICALLY WITHIN THE 1" BORDER.
- G. 3/8" X 1" METAL FRAMEWORK SYSTEM. FIXED TO PANEL WITH ADHESION AND FASTENERS AS REQUIRED. NO FASTENERS ON THE PANEL FACE.







PD-02 Bike Directional Panel Detail Scale: 1-1/2" = 1'-0"

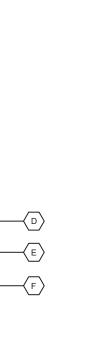





DATE

February 17, 2023

#### NOTE

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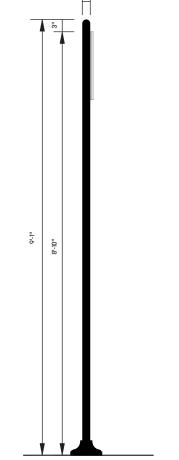
Mississippi State Univeristy Wayfinding and Signage Standards

#### SHEET TITLE

PD-02 Bike Path Layout Details


SHEET NUMBER

26







Scale: 1-1/2" = 1'-0"

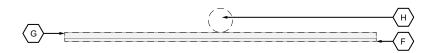

# PD-02 Bike Directional Section Top View

Scale: 1-1/2" = 1'-0"

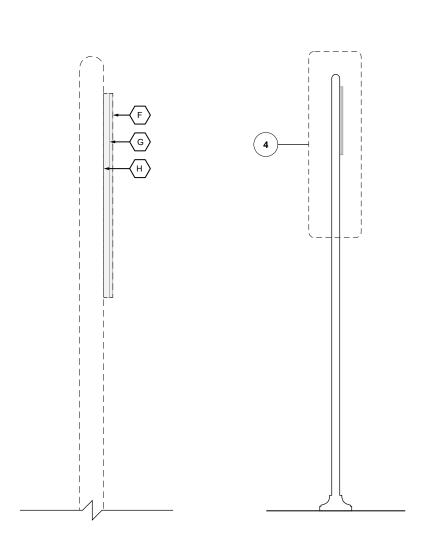

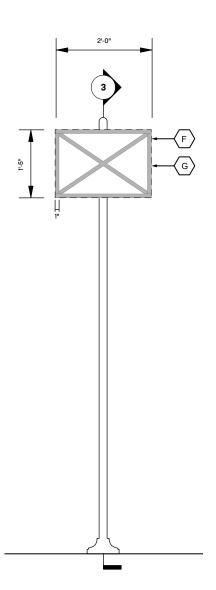

# PD-02 Bike Directional Section Detail

Scale: 1-1/2" = 1'-0"

PD-02 Bike Directional Section

(2)

PD-02 Bike Directional Attachment Detail

cale: 1/2" = 1'-0"


#### LEGEND

\*ALL FOUNDATION DETAILS TO

BE CONFIRMED BY ENGINEER BASED

ON FINAL DESIGN AND LOCATION.\*

- A. 2" DOME CAP TO MATCH HIGH GLOSS INDUSTRIAL BLACK (2 COATS).
- B. 2" SCHEDULE 40 PIPE PAINTED TO MATCH HIGH GLOSS INDUSTRIAL BLACK (2 COATS).
- C. 8" X 8" SIGN BASE BY: ROBINSON IRON OF ALABAMA.
  PAINTED TO MATCH HIGH GLOSS INDUSTRIAL BLACK (2 COATS)
- D. 2" STEEL POST.
- E. 8" CONCRETE FOOTING.
- F. 1/4" THICK ALUMINUM PANEL PAINTED TO MATCH PT.1 AND PT.5
  AS SHOWN. ALL PAINTED ELEMENTS TO RECEIVE A UV RATED
  AND WEATHER PROTECTION CLEAR COATING.
- G. 3/8" X 1" METAL FRAMEWORK SYSTEM. FIXED TO PANEL WITH ADHESION AND FASTENERS AS REQUIRED. NO FASTENERS ON THE PANEL FACE. FRAMEWORK PAINTED OR POWDER COATED TO MATCH ADJACENT PANEL FACE COLORS. ALL PAINTED ELEMENTS TO RECEIVE A UV RATED AND WEATHER PROTECTION CLEAR COATING.
  - BACKER FRAME TO BE WELDED TO EXISTING POST. WELDS GROUND AND SMOOTHED.

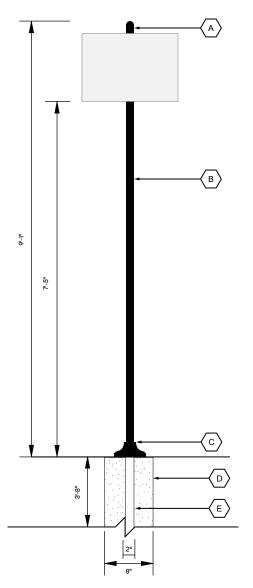

#### PD-02 Bike Directional Context Elevation

Scale: 1/2" = 1'-0"



#### DATE

February 1*7*, 2023

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# PROJECT NAME

Mississippi State Univeristy Wayfinding and Signage Standards

# SHEET TITLE


PD-02 Bike Path Building Details

# SHEET NUMBER


# 1'-4"

# PD-03 Bike Parking Top View



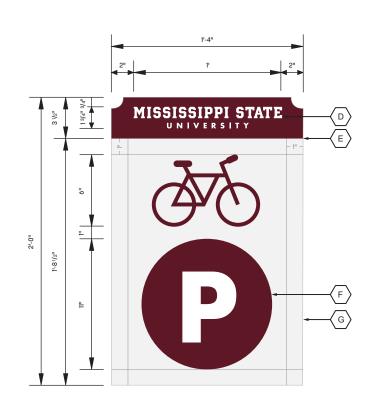

# PD-03 Bike Parking Panel Detail Scale: 1-1/2" = 1'-0"

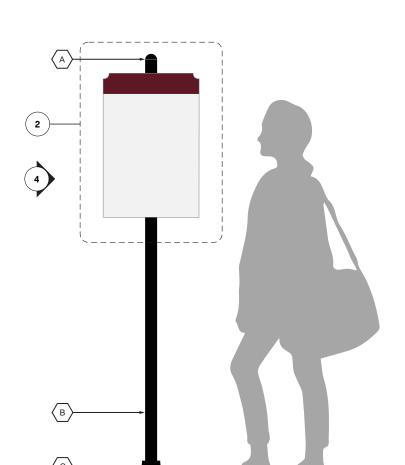

# PD-03 Bike Parking Context Elevation Scale: 3/4" = 1'-0"



- A. 2" DOME CAP TO MATCH HIGH GLOSS INDUSTRIAL BLACK (2 COATS).
- B. 2" SCHEDULE 40 PIPE PAINTED TO MATCH HIGH GLOSS INDUSTRIAL BLACK (2 COATS).
- C. 8" X 8" SIGN BASE BY: ROBINSON IRON OF ALABAMA.
  PAINTED TO MATCH HIGH GLOSS INDUSTRIAL BLACK (2 COATS)
- D. SURFACE APPLIED VINYL MESSAGES TO MATCH V.3 AS SHOWN. FINISHED WITH A UV PROTECTION LAMINATE.
- E. 1/4" THICK ALUMINUM PANEL PAINTED OR POWDER COATED TO MATCH PT.1 AND PT.5 AS SHOWN. ALL PAINTED ELEMENTS TO RECEIVE A UV RATED AND WEATHER PROTECTION CLEAR COATING.
- F. SURFACE APPLIED VINYL MESSAGES TO MATCH V.1 AND V.3 AS SHOWN. FINISHED WITH A UV PROTECTION LAMINATE.
- G. GRAPHICS ARE NOT TO EXCEED THE 1" BORDER SHOWN. TEXT TO BE TYPESET AS SHOWN, THEN CENTER ALIGNED VERTICALLY WITHIN THE 1" BORDER.
- H. 3/8" X 1" METAL FRAMEWORK SYSTEM. FIXED TO PANEL WITH ADHESION AND FASTENERS AS REQUIRED. NO FASTENERS ON THE PANEL FACE.



DATE

February 17, 2023

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# PROJECT NAME

Mississippi State Univeristy Wayfinding and Signage Standards


#### SHEET TITLE

PD-03 Bike Parking Layout Details

# SHEET NUMBER

HEEL NUMB

28

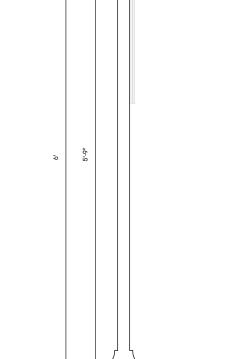





Scale: 3/4" = 1'-0"








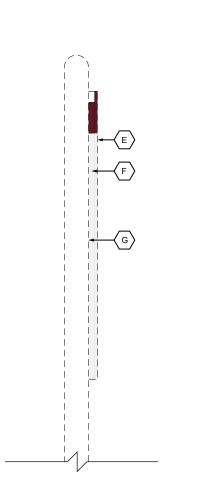

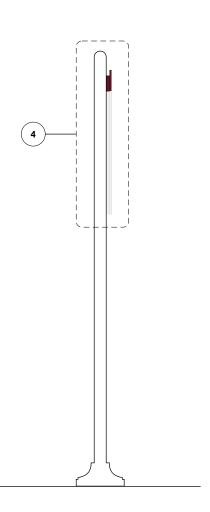

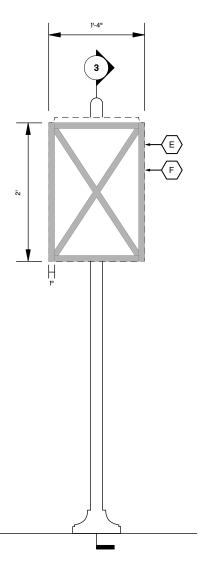


# PD-03 Bike Parking Section Detail Scale: 1-1/2" = 1'-0"





#### LEGEN<sub>I</sub>D

- A. 2" DOME CAP TO MATCH HIGH GLOSS INDUSTRIAL BLACK (2 COATS).
- 2" SCHEDULE 40 PIPE PAINTED TO MATCH HIGH GLOSS INDUSTRIAL BLACK (2 COATS).
- C. 8" X 8" SIGN BASE BY: ROBINSON IRON OF ALABAMA. PAINTED TO MATCH HIGH GLOSS INDUSTRIAL BLACK (2 COATS)
- D. TBD
- E. 1/4" THICK ALUMINUM PANEL PAINTED OR POWDER COATED TO MATCH PT.1 AND PT.5 AS SHOWN. ALL PAINTED ELEMENTS TO RECEIVE A UV RATED AND WEATHER PROTECTION CLEAR
- F. 3/8" X 1" METAL FRAMEWORK SYSTEM. FIXED TO PANEL WITH ADHESION AND FASTENERS AS REQUIRED. NO FASTENERS ON THE PANEL FACE. FRAMEWORK PAINTED OR POWDER COATED TO MATCH ADJACENT PANEL FACE COLORS. ALL PAINTED ELEMENTS TO RECEIVE A UV RATED AND WEATHER PROTECTION CLEAR COATING.
- BACKER FRAME TO BE WELDED TO EXISTING POST. WELDS GROUND AND SMOOTHED.

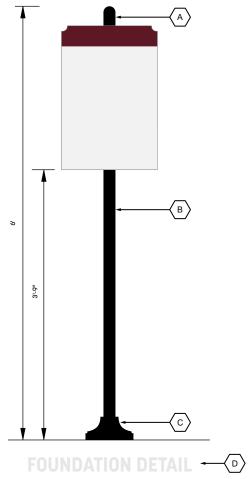

PD-03 Bike Parking Foundation Detail

Scale: 3/4" = 1'-0"



DATE

February 17, 2023

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PROJECT NAME

Mississippi State Univeristy Wayfinding and Signage Standards

SHEET TITLE

PD-03 Bike Parking **Building Details** 

SHEET NUMBER

# 2'-6" 1'-10" GO RIGHT FOR **MONTGOMERY HALL PROSPECTIVE STUDENTS**

**PD-04 Prospective Student Detail** 

Scale: 1" = 1'

LEGEND

A. SURFACE APPLIED PAINTED GRAPHIC TO MATCH P.1, P.4, AND P.3 AS SHOWN. FINISHED WITH A UV PROTECTION CLEAR COAT. APPLIED TO EXISTING CONCRETE PAVER ON GROUND SURFACE.



DATE

February 17, 2023

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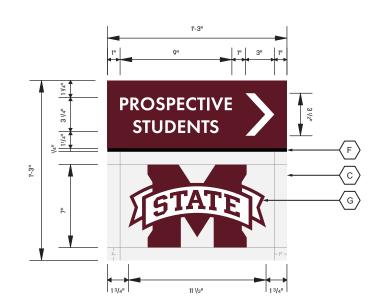
# PROJECT NAME

Mississippi State Univeristy Wayfinding and Signage Standards

# SHEET TITLE

PD-04 Prospective Student Signage Painted Ground Sign

SHEET NUMBER




# PD-04 Prospective Student Top View

Scale: 1-1/2" = 1'-0"

PD-04 Prospective Student Detail

Scale: 1-1/2" = 1'-0"

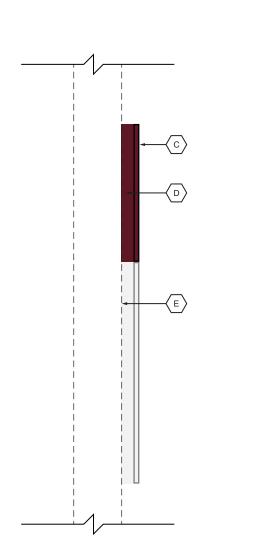


PD-04 Prospective Student Section Detail

Scale: 3" = 1'-0"

Scale: 1/2" = 1'-0"

**PD-04 Prospective Student Section** 

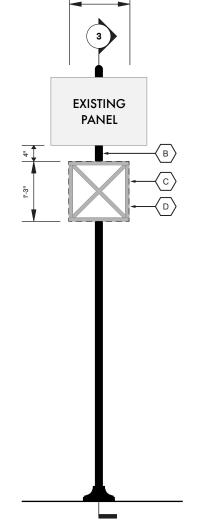


# PD-04 Prospective Student Attachment Detail

Scale: 1/2" = 1'-0"

#### LEGEND

- A. EXISTING POST FOR REFERENCE.
- B. SIGNS TO BE MOUNTED 4" BELOW ANY EXISTING SIGNAGE.
- C. 1/4" THICK ALUMINUM PANEL PAINTED OR POWDER COATED TO MATCH PT.1 AND PT.5 AS SHOWN. ALL PAINTED ELEMENTS TO RECEIVE A UV RATED AND WEATHER PROTECTION CLEAR COATING.
- D. 3/8" X 1" METAL FRAMEWORK SYSTEM. FIXED TO PANEL WITH ADHESION AND FASTENERS AS REQUIRED. NO FASTENERS ON THE PANEL FACE. FRAMEWORK PAINTED OR POWDER COATED TO MATCH ADJACENT PANEL FACE COLORS. ALL PAINTED ELEMENTS TO RECEIVE A UV RATED AND WEATHER PROTECTION CLEAR COATING.
- E. BACKER FRAME TO BE WELDED TO EXISTING POST. WELDS GROUND AND SMOOTHED.
- F. PAINTED OR POWDER COATED RULE LINE TO MATCH BLACK.
- . SURFACE APPLIED VINYL MESSAGES TO MATCH V.1 AND V.3 AS SHOWN. FINISHED WITH A UV PROTECTION LAMINATE.

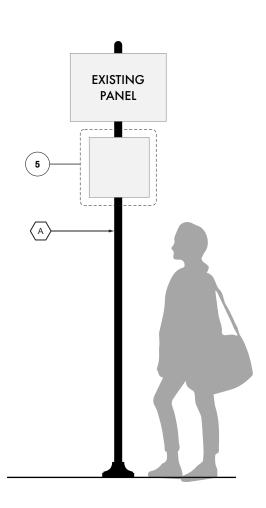

**PD-04 Prospective Student Context Elevation** 

Scale: 1/2" = 1'-0"



DATE

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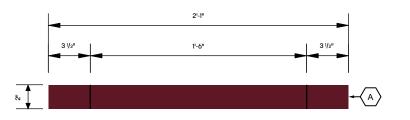



Mississippi State Univeristy Wayfinding and Signage Standards


#### SHEET TITLE

PD-04 Prospective Student Signage Pole Mounted Wayfinding

SHEET NUMBER




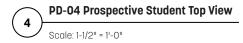

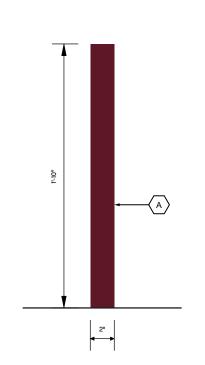


**PD-04 Prospective Student Side View** 

Scale: 1-1/2" = 1'-0"

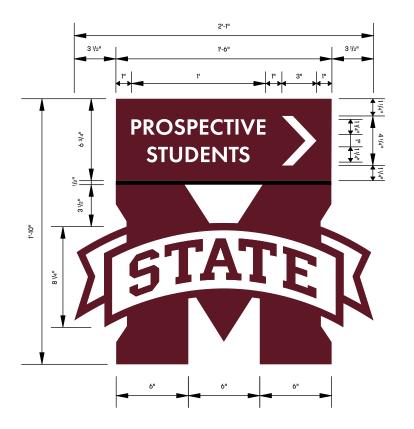



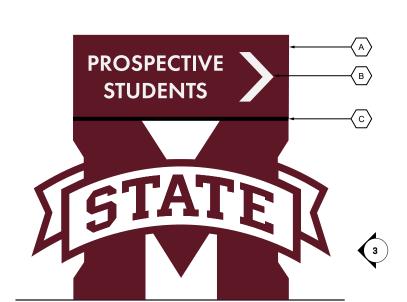

**PD-04 Prospective Student Context Elevation** Scale: 1-1/2" = 1'-0"



- A. 2" THICK CUSTOM FABRICATED SIGNAGE CABINET. CONSTRUCTED IN THE SHAPE OF THE MISSISSIPPI STATE UNIVERSITY LOGO FORM. "STATE" RIBBON TO BE INCLUDED IN THE SIGNAGE SHAPE AND "STATE" TEXT TO BE STENCIL-CUT PAINTED. CENTER APEX OF "M" KNOCKED OUT. PAINTED OR POWDER COATED TO MATCH PT.1 AND PT.5 AS SHOWN. ALL PAINTED ELEMENTS TO RECEIVE A UV RATED AND WEATHER PROTECTION CLEAR COATING.
- SURFACE APPLIED VINYL MESSAGES TO MATCH V.3. FINISHED WITH A UV PROTECTION LAMINATE.
- C. PAINTED OR POWDER COATED RULE LINE TO MATCH BLACK.



DATE

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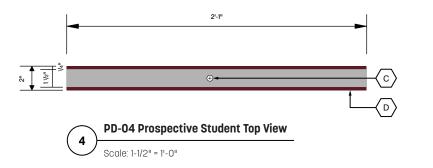
PROJECT NAME


Mississippi State Univeristy Wayfinding and Signage Standards

# SHEET TITLE

PD-04 Prospective Student Signage Ground Mounted Wayfinding Layout Details

SHEET NUMBER



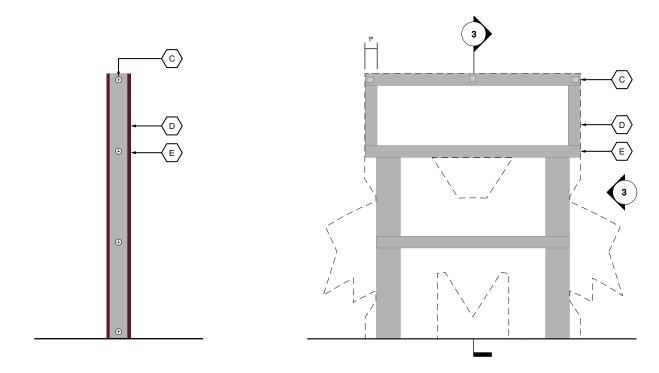

PD-04 Prospective Student Side View

Scale: 1-1/2" = 1'-0"


PD-04 Prospective Student Attachment Detail

| Scale: 1-1/2" = 1'-0"

\*ALL FOUNDATION DETAILS TO BE CONFIRMED BY ENGINEER BASED ON FINAL DESIGN AND LOCATION.\*

#### LEGEND

- A. 2" X 1-1/2" INTERNAL TUBE MOUNTING STRUCTURE BURIED 3' UNDERGROUND. FILLED IN WITH GRAVEL.
- B. GRAVEL BACKFILL AROUND POST.
- C. SIGN FACE ATTACHED TO INTERNAL STRUCTURE WITH COUNTERSUNK ON SIGNAGE RETURNS, TOP, AND BOTTOM FOR SEAMLESS LOOK ON SIGN FACE. INTERNAL MOUNTING AND WELDING AS NEEDED. FASTENERS PAINTED TO MATCH ADJACENT CABINET FACE.
- D. 1/4" THICK SIGN CABINET FACE PAINTED TO MATCH PT.1 AS SHOWN.
- E. 1" X 1-1/2" INTERNAL TUBE MOUNTING STRUCTURE.

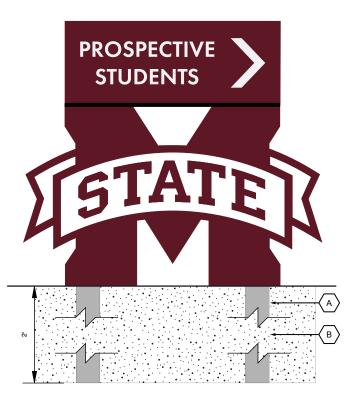

PD-04 Prospective Student Foundation Detail

| Scale: 1-1/2" = 1'-0"



DATE

February 17, 2023

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# PROJECT NAME


Mississippi State Univeristy Wayfinding and Signage Standards

# SHEET TITLE

PD-04 Prospective Student Signage Ground Mounted Wayfinding Building Details


SHEET NUMBER

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# **REG-01 No Smoking Side View** Scale: 3" = 1'-0"

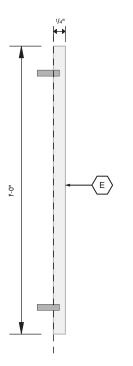




**REG-01 No Smoking Wall-Mounted Condition Context Elevation** 

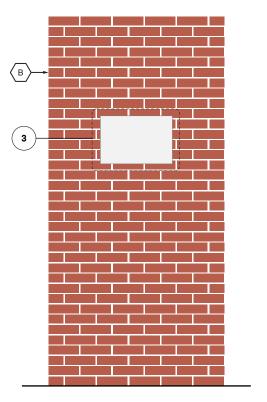Scale: 1/2" = 1'-0"

#### LEGEND

- A. EXISTING POST FOR REFERENCE.
- EXISTING WALL FOR REFERENCE.
- TEXT AND GRAPHICS NOT TO EXCEED THE 1" BORDER SHOWN.
- SURFACE APPLIED VINYL MESSAGES. FINISHED WITH A UV PROTECTION LAMINATE.
- E. 1/4" THICK ALUMINUM PANEL PAINTED OR POWDER COATED TO MATCH PT.5 AS SHOWN. ALL PAINTED ELEMENTS TO RECEIVE A UV RATED AND WEATHER PROTECTION CLEAR COATING.

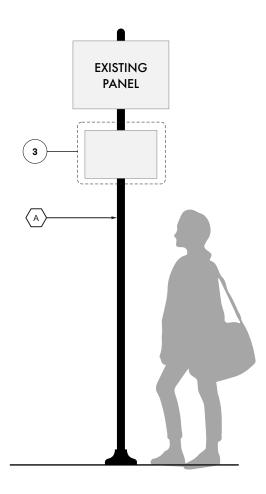

**REG-01 No Smoking Post-Mounted Condition Context Elevation** 

Scale: 1/2" = 1'-0"



DATE

February 17, 2023

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# PROJECT NAME

Mississippi State Univeristy Wayfinding and Signage Standards

#### SHEET TITLE


REG-01 No Smoking Layout Details


SHEET NUMBER



#### LEGEND

- A. EXISTING POST FOR REFERENCE.
- SIGNS TO BE MOUNTED 4" BELOW ANY EXISTING SIGNAGE.
- C. EXISTING WALL FOR REFERENCE.
- D. 3/8" THICK ALUMINUM PANEL PAINTED OR POWDER COATED TO MATCH PT.5 AS SHOWN. ALL PAINTED ELEMENTS TO RECEIVE A UV RATED AND WEATHER PROTECTION CLEAR COATING.
- E. PANEL MECHANICALLY FASTENED TO EXISTING POST WITH COUNTERSUNK SCREWS. PAINTED TO MATCH ADJACENT PANEL COLOR.

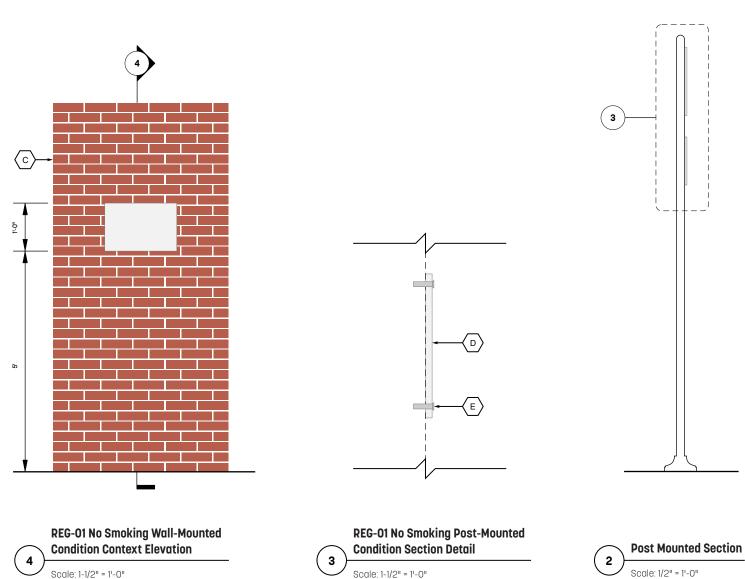

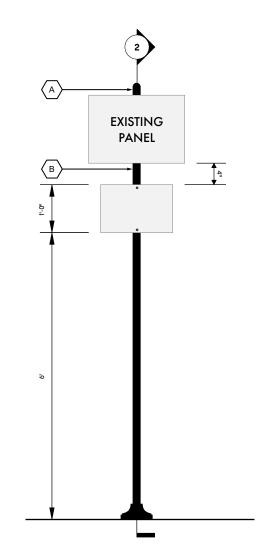

REG-01 No Smoking Post-Mounted Condition Context Elevation

Scale: 1-1/2" = 1'-0"



DATE

February 17, 2023

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PROJECT NAME

Mississippi State Univeristy Wayfinding and Signage Standards

SHEET TITLE

REG-01 No Smoking Building Details


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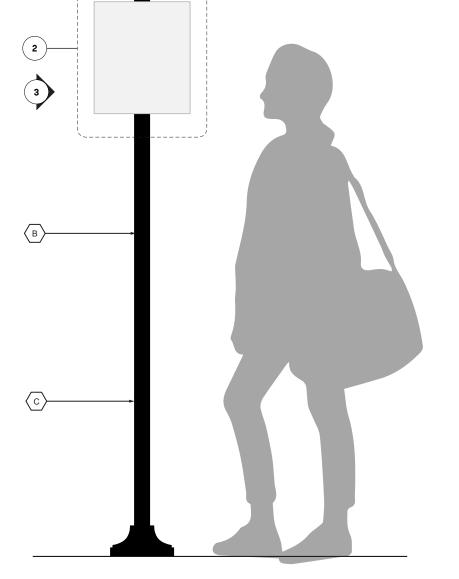
#### LEGEND

- A. 2" DOME CAP TO MATCH HIGH GLOSS INDUSTRIAL BLACK (2 COATS).
- B. 2" SCHEDULE 40 PIPE PAINTED TO MATCH HIGH GLOSS INDUSTRIAL BLACK (2 COATS).
- C. 8" X 8" SIGN BASE BY: ROBINSON IRON OF ALABAMA.
  PAINTED TO MATCH HIGH GLOSS INDUSTRIAL BLACK (2 COATS)
- D. SURFACE APPLIED VINYL MESSAGES TO MATCH V.1 AS SHOWN. FINISHED WITH A UV PROTECTION LAMINATE.
- E. GRAPHICS ARE NOT TO EXCEED THE 1" BORDER SHOWN.
  TEXT TO BE TYPESET AS SHOWN, THEN CENTER ALIGNED
  VERTICALLY WITHIN THE 1" BORDER.
- F. 1/4" THICK ALUMINUM PANEL PAINTED OR POWDER COATED TO MATCH PT.1 AND PT.5 AS SHOWN. ALL PAINTED ELEMENTS TO RECEIVE A UV RATED AND WEATHER PROTECTION CLEAR COATING.
- G. 3/8" X 1" METAL FRAMEWORK SYSTEM. FIXED TO PANEL WITH ADHESION AND FASTENERS AS REQUIRED. NO FASTENERS ON THE PANEL FACE.







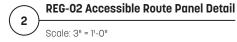

REG-02 Accessible Route Context Elevation

Scale: 1" = 1'-0"



DATE

February 17, 2023

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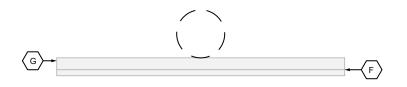
#### PROJECT NAME

Mississippi State Univeristy Wayfinding and Signage Standards


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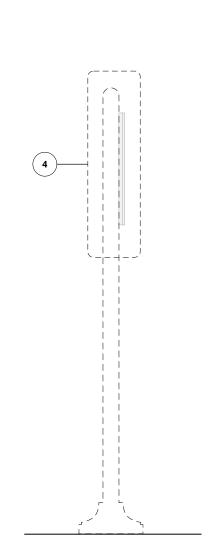
REG-02 Accessible Route Layout Details


SHEET NUMBER




**REG-02 Accessible Route Top View** 



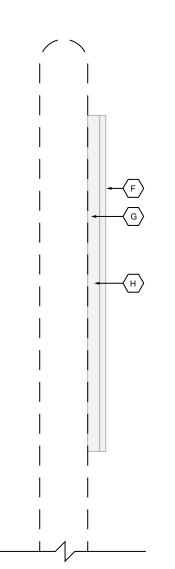

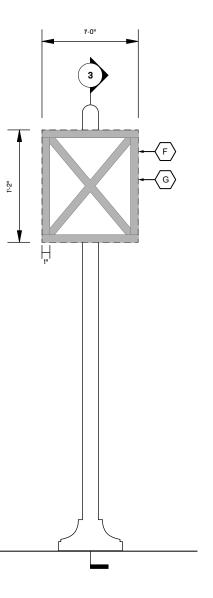




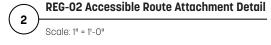



ON FINAL DESIGN AND LOCATION.\*

- A. 2" DOME CAP TO MATCH HIGH GLOSS INDUSTRIAL BLACK (2 COATS).
- B. 2" SCHEDULE 40 PIPE PAINTED TO MATCH HIGH GLOSS INDUSTRIAL BLACK (2 COATS).
- C. 8" X 8" SIGN BASE BY: ROBINSON IRON OF ALABAMA. PAINTED TO MATCH HIGH GLOSS INDUSTRIAL BLACK (2 COATS)
- E. 8" CONCRETE FOOTING.
- F. 1/4" THICK ALUMINUM PANEL PAINTED OR POWDER COATED TO MATCH PT.5 AS SHOWN. ALL PAINTED ELEMENTS TO RECEIVE A UV RATED AND WEATHER PROTECTION CLEAR COATING.
- G. 3/8" X 1" METAL FRAMEWORK SYSTEM. FIXED TO PANEL WITH ADHESION AND FASTENERS AS REQUIRED. NO FASTENERS ON THE PANEL FACE. FRAMEWORK PAINTED OR POWDER COATED TO MATCH ADJACENT PANEL FACE COLORS. ALL PAINTED ELEMENTS TO RECEIVE A UV RATED AND WEATHER PROTECTION CLEAR COATING.
- H. BACKER FRAME TO BE WELDED TO EXISTING POST. WELDS GROUND AND SMOOTHED.

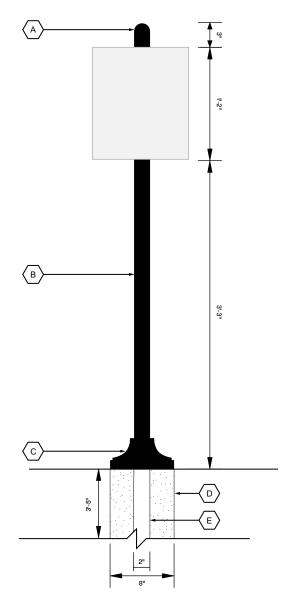

**REG-02 Accessible Route Foundation Detail** 



DATE

February 17, 2023

NOTE

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PROJECT NAME

Mississippi State Univeristy Wayfinding and Signage Standards


SHEET TITLE


REG-02 Accessible Route **Building Details** 


SHEET NUMBER

37

**REG-02 Accessible Route Section Detail** 

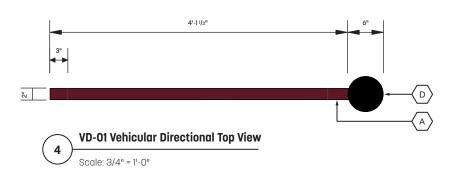

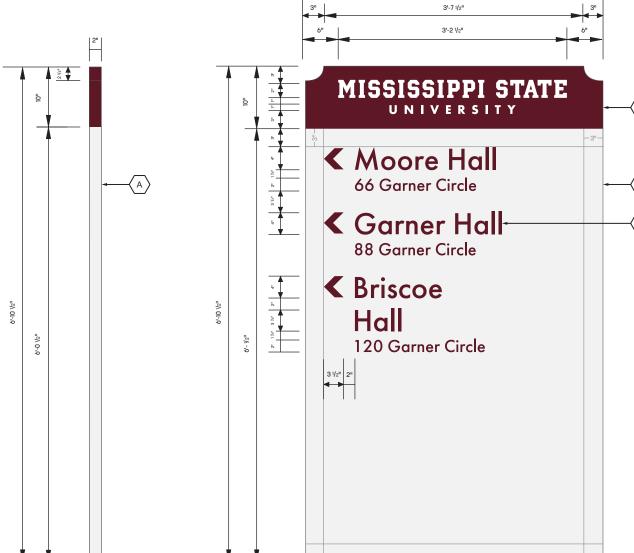

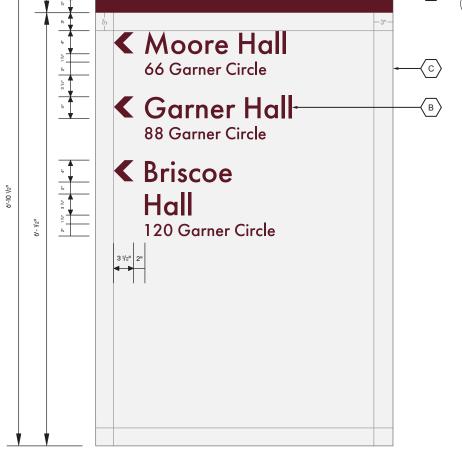

4'-11/2"



VD-01 Vehicular Directional Panel Detail Scale: 3/4" = 1'-0"

**VD-01 Vehicular Directional Context Elevation** Scale: 3/8" = 1'-0"

MISSISSIPPI STATE

**(2)** 

#### LEGEND

- A. 2" THICK FABRICATED ALUMINUM SIGNAGE CABINET SLEEVE. COVE EDGE DETAILING ON CABINET TOP. FABRICATED CABINET SLEEVE WILL HAVE INTERNAL STRUCTURE AS NEEDED WITH HIDDEN FASTENERS. ALL EXPOSED WELDS TO BE GROUND AND SMOOTHED. CABINET PAINTED OR POWDER COATED TO MATCH PT.1 AND PT.5 AS SHOWN. ALL PAINTED ELEMENTS TO RECEIVE A UV RATED AND WEATHER PROTECTION CLEAR
- B. SURFACE APPLIED VINYL MESSAGES TO MATCH V.1 AND V.3 AS SHOWN. FINISHED WITH A UV PROTECTION LAMINATE.
- C. GRAPHICS ARE NOT TO EXCEED THE 3" BORDER SHOWN. FIRST LINE TO BE ALIGNED 3" FROM THE TOP OF THE GREY PANEL. ARROW TO BE CENTERED WITH THE TOP LINE OF TEXT. ANY STACK GREATER THAN TWO LINES IS TO FOLLOW THE SPACING CONVENTIONS OF THE TWO LINE EXAMPLE.
- D. EXISTING SIGN POST FOR REFERENCE. 6" DIAMETER STAINLESS STEEL POST WITH DOME CAP AND FINIAL WITH A DECORATIVE BASE PLATE.
- E. EXISTING SIGN POST FOUNDATION FOR REFERENCE. SEE NEXT PAGE FOR DETAILS.



DATE

February 17, 2023

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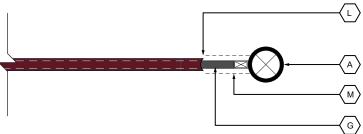
PROJECT NAME

Mississippi State Univeristy Wayfinding and Signage Standards


SHEET TITLE

VD-01 Vehicular Directional Layout Details

SHEET NUMBER



VD-01 Vehicular Directional Top View Sleeve Detail Scale: 3/4" = 1'-0"

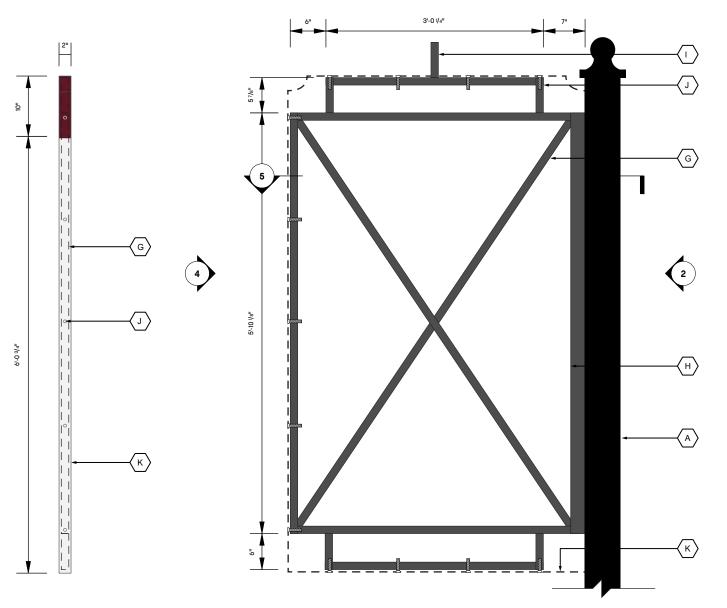

**VD-01 Vehicular Directional Side View** 

Scale: 3/4" = 1'-0"






Scale: 3/4" = 1'-0"

#### LEGEND

- A. EXISTING FOUNDATION FOR REFERENCE. 6" DIAMETER STAINLESS STEEL POST WITH DOME CAP AND FINIAL. DECORATIVE BASE PLATE.
- EXISTING FOUNDATION FOR REFERENCE. 6" DIAMETER STEEL SCHEDULE 40 POST.
- C. EXISTING FOUNDATION FOR REFERENCE. 3" X 6" TABS WELDED TO STEEL POST FOR WIND TURN RESISTANCE.
- D. EXISTING FOUNDATION FOR REFERENCE. 3500 PSI CONCRETE
- E. EXISTING FOUNDATION FOR REFERENCE. 610 LIMESTONE.
- 2" THICK SIGN CABINET SLEEVE. ONE SIDE OF SLEEVE REMOVED TO SLOT OVER EXISTING SIGNAGE MOUNTING STRUCTURE.
- EXISTING 1.25" THICK STEEL TUBING MOUNTING STRUCTURE.
- EXISTING TUBE MOUNTING STRUCTURE WELDED TO EXISTING POST.
- TOP ELEMENT OF EXISTING TUBE MOUNTING STRUCTURE TO BE REMOVED FOR ALL EXISTING LOCATIONS.
- SIGN CABINET SLEEVE ATTACHED TO EXISTING STEEL TUBE MOUNTING STRUCTURE WITH MECHANICAL FASTENERS ON TOP, SIDE AND BOTTOM OF CABINET. ALL FASTENERS PAINTED TO MATCH ADJACENT CABINET FACE. COUNTERSUNK FOR SEAMLESS LOOK.
- 2" THICK SIGN CABINET SLEEVE.
- OPEN CABINET SLEEVE SIDE TO BE CURVED TO SLOT SEAMLESSLY INTO EXISTING ROUNDED POST.
- M. SLEEVE MOUNTING AND ATTACHMENT PATH FOR REFERENCE.

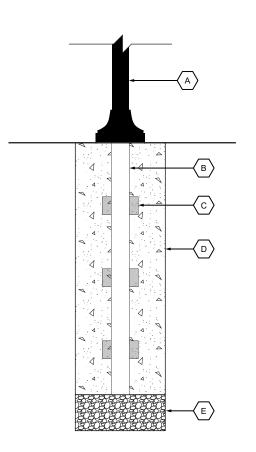

Scale: 3/8" = 1'-0"

**VD-01 Vehicular Directional Foundation Detail** 

PROJECT NAME Mississippi State Univeristy Wayfinding and Signage

Standards

SHEET TITLE

**Building Details** 

VD-01 Vehicular Directional

SHEET NUMBER

39



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for verification of all dimensions and field condition

prior to performing the work, and inform this office of  $% \left\{ \left( 1\right) \right\} =\left\{ \left( 1\right) \right\}$ 

any variations. Written dimensions shall have authority

over scaled dimensions. Designs and ideas put forth in this document have been prepared for the below

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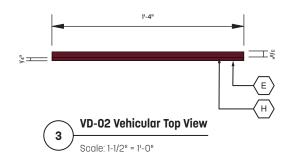
DATE

NOTE

February 17, 2023

VD-02 Vehicular Parking Side View

Scale: 1/2" = 1'-0"



# MISSISSIPPI STATE Service **Parking**




# VD-02 Vehicular Parking Panel Detail Double Line Text

2B

VD-02 Vehicular Parking Panel Detail Single Line Text 2A

#### LEGEN<sub>I</sub>D

- A. 2" DOME CAP TO MATCH HIGH GLOSS INDUSTRIAL BLACK (2 COATS).
- 2" SCHEDULE 40 PIPE PAINTED TO MATCH HIGH GLOSS INDUSTRIAL BLACK (2 COATS).
- C. 8" X 8" SIGN BASE BY: ROBINSON IRON OF ALABAMA. PAINTED TO MATCH HIGH GLOSS INDUSTRIAL BLACK (2 COATS)
- D. SURFACE APPLIED VINYL MESSAGES TO MATCH V.3 AS SHOWN. FINISHED WITH A UV PROTECTION LAMINATE.
- E. 1/4" THICK ALUMINUM PANEL PAINTED OR POWDER COATED TO MATCH PT.1 AND PT.5 AS SHOWN. ALL PAINTED ELEMENTS TO RECEIVE A UV RATED AND WEATHER PROTECTION CLEAR
- F. GRAPHICS ARE NOT TO EXCEED THE 1" BORDER SHOWN. TEXT TO BE TYPESET AS SHOWN, THEN CENTER ALIGNED VERTICALLY WITHIN THE 1" BORDER.
- G. SURFACE APPLIED VINYL MESSAGES TO MATCH V.1 AND V.3 AS SHOWN. FINISHED WITH A UV PROTECTION LAMINATE.
- H. 3/8" X 1" METAL FRAMEWORK SYSTEM. FIXED TO PANEL WITH ADHESION AND FASTENERS AS REQUIRED. NO FASTENERS ON THE PANEL FACE.

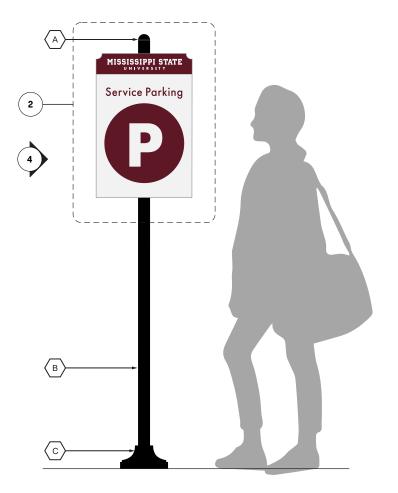

**VD-02 Vehicular Parking Context Elevation** 



DATE

February 17, 2023

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Mississippi State Univeristy Wayfinding and Signage Standards


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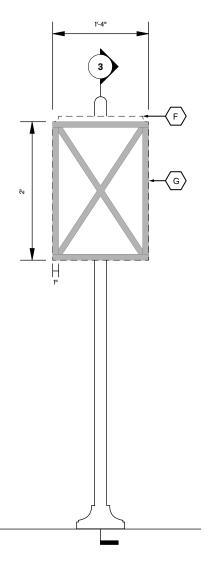
VD-02 Vehicular Parking Layout Details

SHEET NUMBER









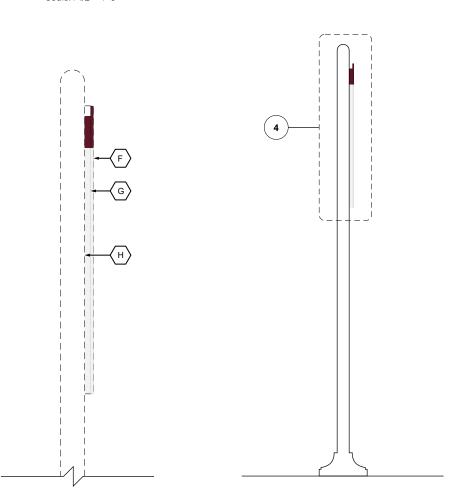

# VD-02 Vehicular Parking Section Detail Scale: 1-1/2" = 1'-0"

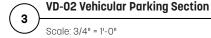


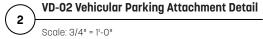

# \*ALL FOUNDATION DETAILS TO BE CONFIRMED BY ENGINEER BASED A. 2"

ON FINAL DESIGN AND LOCATION.\*

- A. 2" DOME CAP TO MATCH HIGH GLOSS INDUSTRIAL BLACK (2 COATS).
- B. 2" SCHEDULE 40 PIPE PAINTED TO MATCH HIGH GLOSS INDUSTRIAL BLACK (2 COATS).
- C. 8" X 8" SIGN BASE BY: ROBINSON IRON OF ALABAMA.
  PAINTED TO MATCH HIGH GLOSS INDUSTRIAL BLACK (2 COATS).
- D. 2" STEEL POST.
- E. 8" CONCRETE FOOTING.
- F. 1/4" THICK ALUMINUM PANEL PAINTED OR POWDER COATED TO MATCH PT.1 AND PT.5 AS SHOWN. ALL PAINTED ELEMENTS TO RECEIVE A UV RATED AND WEATHER PROTECTION CLEAR COATING.
- G. 3/8" X 1" METAL FRAMEWORK SYSTEM. FIXED TO PANEL WITH ADHESION AND FASTENERS AS REQUIRED. NO FASTENERS ON THE PANEL FACE. FRAMEWORK PAINTED OR POWDER COATED TO MATCH ADJACENT PANEL FACE COLORS. ALL PAINTED ELEMENTS TO RECEIVE A UV RATED AND WEATHER PROTECTION CLEAR COATING.
- H. BACKER FRAME TO BE WELDED TO EXISTING POST. WELDS GROUND AND SMOOTHED.

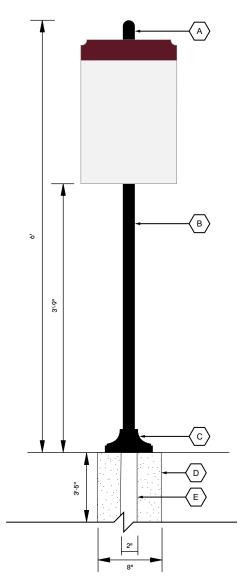

VD-02 Vehicular Parking Foundation Detail

Scale: 3/4" = 1'-0"



DATE

February 17, 2023

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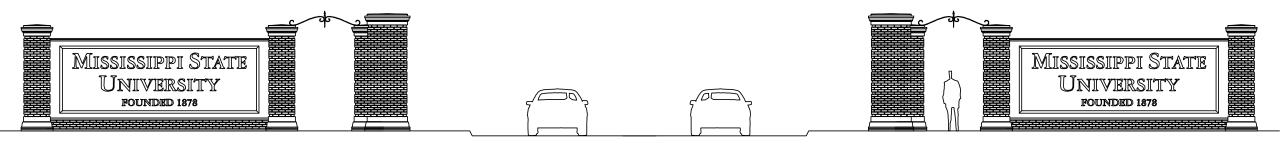
Mississippi State Univeristy Wayfinding and Signage Standards

## SHEET TITLE

VD-02 Vehicular Parking Building Details

SHEET NUMBER

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Campus Gateway Hwy 12/Stone Blvd



Hwy 12/Bully Blvd



Hwy 82/North Entrance Road



DATE

February 17, 2023

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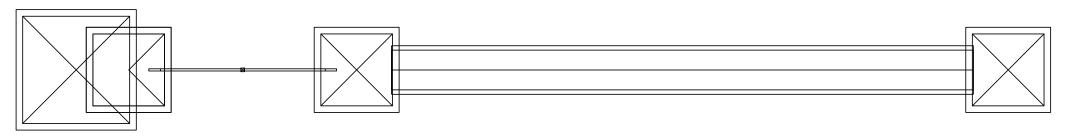
PROJECT NAME

Mississippi State Univeristy Wayfinding and Signage Standards


SHEET TITLE

Existing Gateway Entry

SHEET NUMBER



#### PLAN VIEW

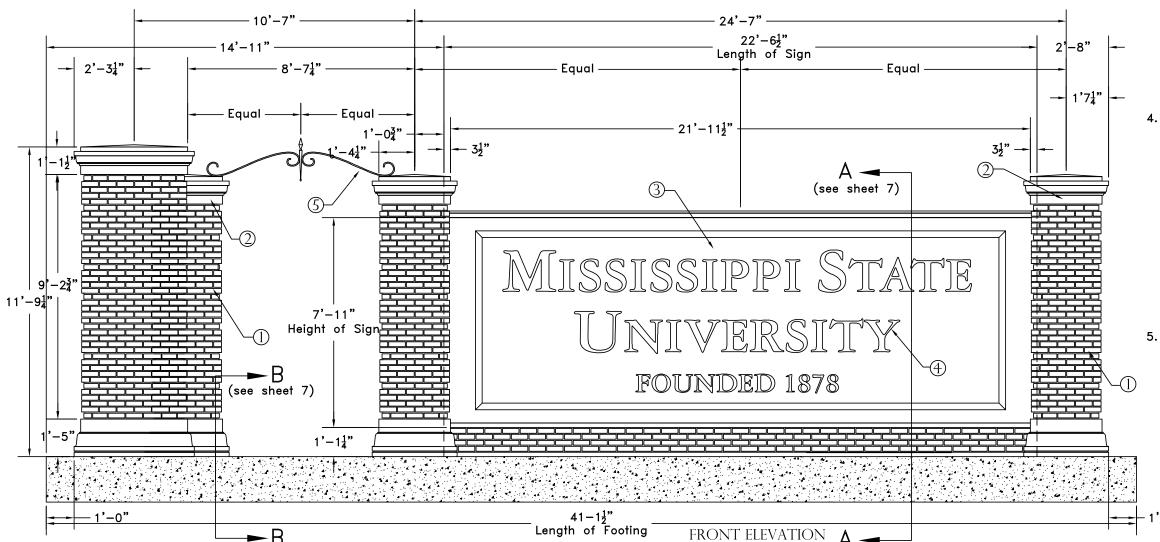

#### Notes:

- Columns to be brick masonry, built around internal cinderblock structure, To match design layout to existing historic brick gateway structure. This includes matching the brick bond where every fifth course is inset. Brick material/color to match University Standards as found in campus clock tower construction.
- Column caps to be cast concrete
   or slab limestone to match a cream/off
   white color. Top of caps to have a
   slight slope to prevent standing water.
   Column bases to be cast concrete or
   limestone, built around internal cinder—
   block structure, to match cream/ off
   white color.
- 3. Center wall to be cast concrete or slab limestone, built around internal steel frame structure, to match cream/off white color. Base of wall to be brick masonry, built around 4000 PSI concrete footing to match design layout to existing historic brick gateway structure. Brick material/color to match University Standards as found in campus clock tower construction.
- 4. Letterforms to be ½" thick solid plate aluminum with a vertically brushed U.S. #4, pure black anodized finish on the face and returns. Typestyle: garamond 3 Bold, large and small caps.

All edges and corners to be slightly eased on crisp, clean. 90° returns.

Letterforms to be mounted 1" off wall with threaded studs set in a 2-part epoxy. Exposed studs to be inserted thru aluminum sleeves painted to match wall color.

(P-1 Cream/Off White)

5. Accent to be ½" thick x 1" solid aluminum with a brushed U.S. #4, black anodized finish an all sides.



DATE

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PROJECT NAME


Mississippi State Univeristy Wayfinding and Signage Standards

SHEET TITLE


SHEET TILLE

Existing Gateway Entry

SHEET NUMBER

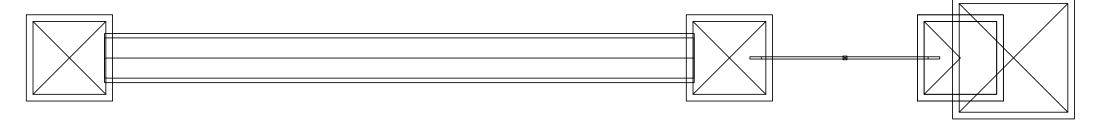

#### PLAN VIEW

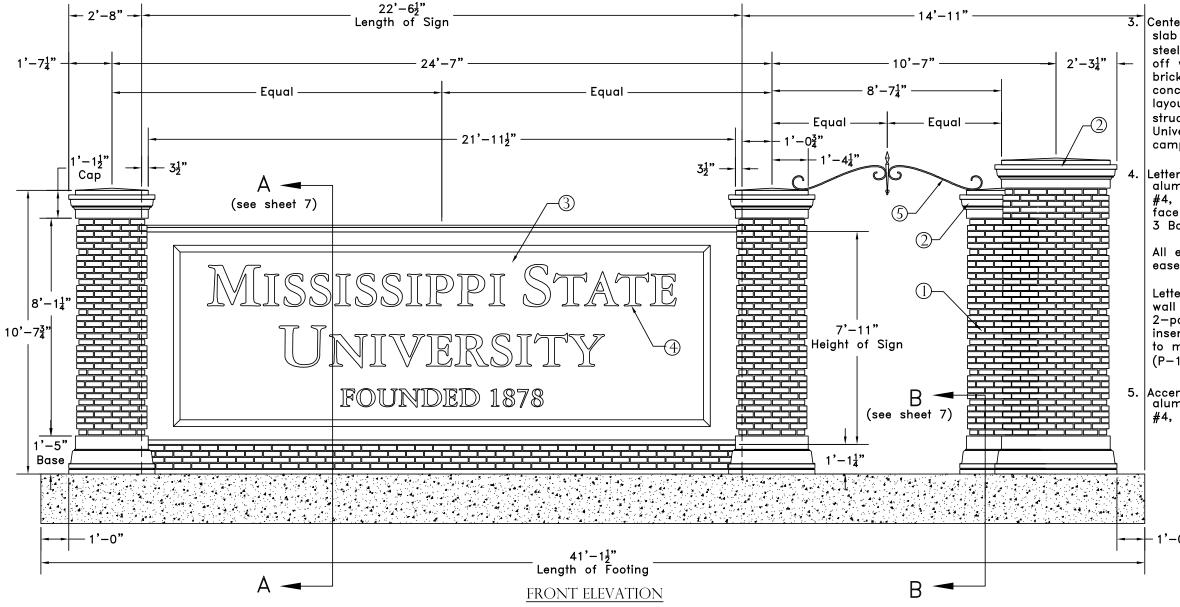

#### Notes:

- Columns to be brick masonry, built around internal cinderblock structure, To match design layout to existing historic brick gateway structure. This includes matching the brick bond where every fifth course is inset. Brick material/color to match University Standards as found in campus clock tower construction.
- 2. Column caps to be cast concrete or slab limestone to match a cream/off white color. Top of caps to have a slight slope to prevent standing water. Column bases to be cast concrete or limestone, built around internal cinder—block structure, to match cream/ off white color.

3. Center wall to be cast concrete or slab limestone, built around internal steel frame structure, to match cream/off white color. Base of wall to be brick masonry, built around 4000 PSI concrete footing to match design layout to existing historic brick gateway structure. Brick material/color to match University Standards as found in campus clock tower construction.

Letterforms to be ½" thick solid plate aluminum with a vertically brushed U.S. #4, pure black anodized finish on the face and returns. Typestyle: garamond 3 Bold, large and small caps.

All edges and corners to be slightly eased on crisp, clean. 90° returns.

Letterforms to be mounted 1" off wall with threaded studs set in a 2-part epoxy. Exposed studs to be inserted thru aluminum sleeves painted to match wall color.

(P-1 Cream/Off White)

Accent to be ½" thick x 1" solid aluminum with a brushed U.S. #4, black anodized finish an all sides.



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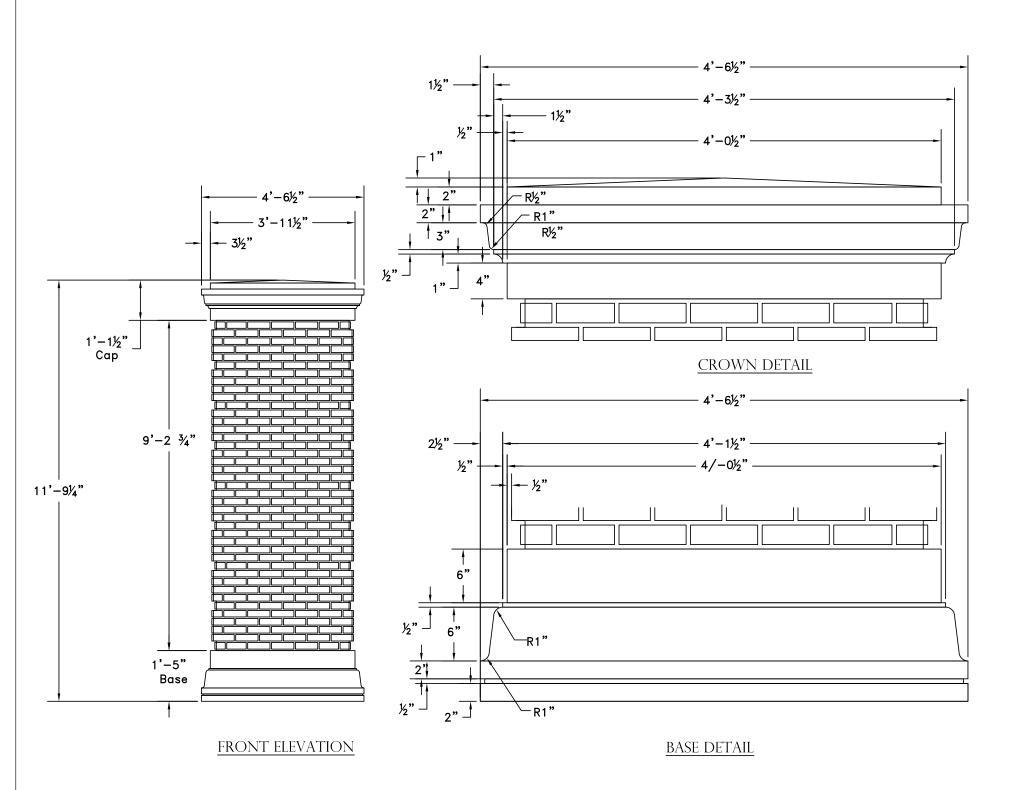
### PROJECT NAME

Mississippi State Univeristy Wayfinding and Signage Standards

#### SHEET TITLE

Existing Gateway Entry

SHEET NUMBER



#### Notes:

- 1. Columns to be brick masonry, built around internal cinderblock structure, to match/or simialar to existing brick gateway structure or clock tower. this includes matching the brick bond where every fifth course is inset in.
- 2. Column concrete caps to be 3" thick cast concrete to match a cream or off white color. caps to have a slight slope to prevent standing water.
- 3. Column concrete bases to be cast concrete, built around internal cinderblock structure, to match a cream or off white color.



DATE

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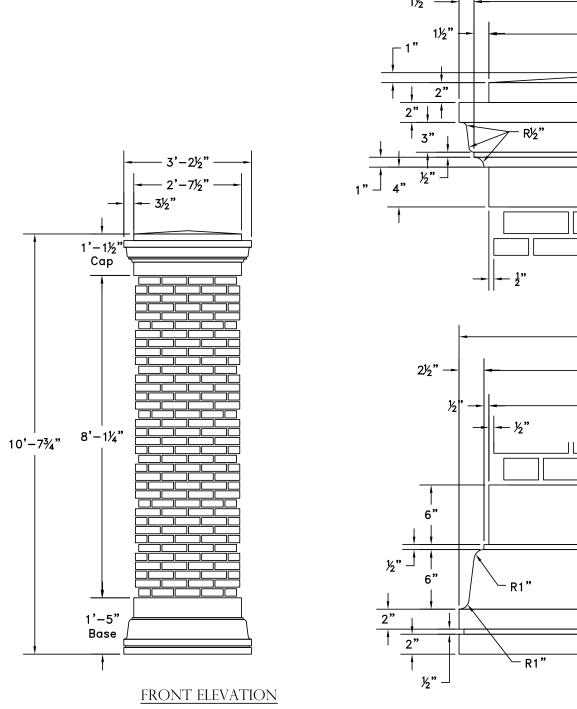
PROJECT NAME

Mississippi State Univeristy Wayfinding and Signage Standards

SHEET TITLE

Existing Gateway Entry

SHEET NUMBER





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- Column concrete caps to be 3" thick cast concrete to match a cream or off white color. caps to have a slight slope to prevent standing water.
- Column concrete bases to be cast concrete, built around internal cinderblock structure, to match a cream or off white color.



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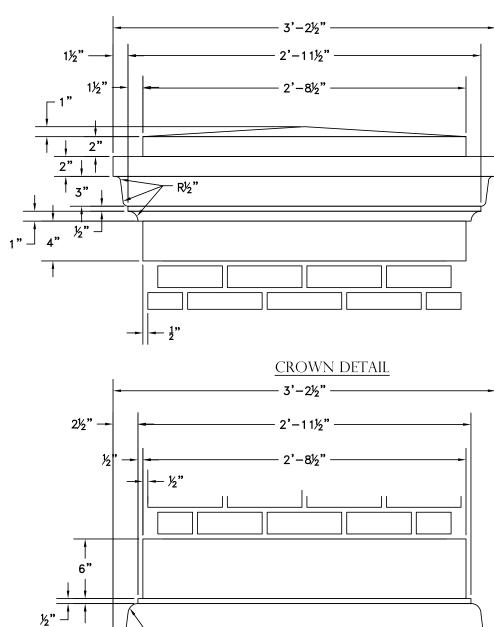
Mississippi State Univeristy Wayfinding and Signage Standards

SHEET TITLE

Existing Gateway Entry


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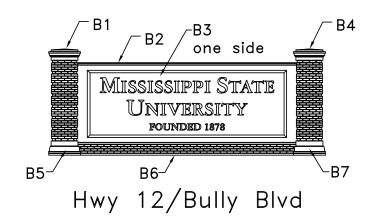
46




BASE DETAIL

# Bid Items



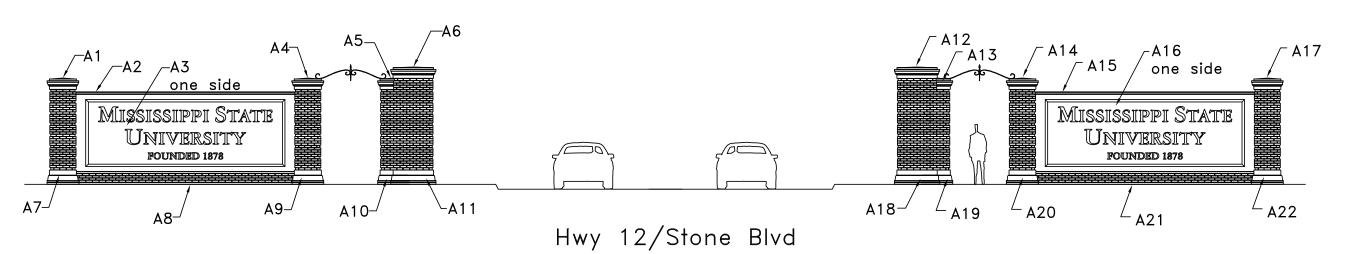

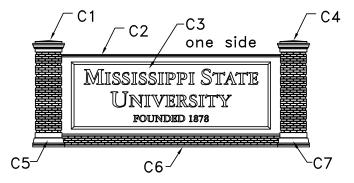

Hwy 82/North Entrance Road



DATE

February 17, 2023

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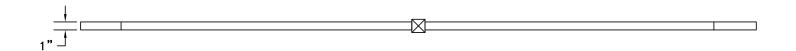
PROJECT NAME

Mississippi State Univeristy Wayfinding and Signage Standards

SHEET TITLE

BID-01 Neighborhood Gateway

SHEET NUMBER



# PLAN VIEW Equal Equal 11" 1'-7½"

FRONT ELEVATION



SIDE VIEW

#### Notes:

by owner.

- 1. Accent to be  $\frac{1}{2}$ " thick x 1" solid aluminum with a brushed U.S. #4, black anodized finish on sides.
- 2. Accent to be mechanically fastened to cast concrete or slab limestone caps.



DATE

February 17, 2023

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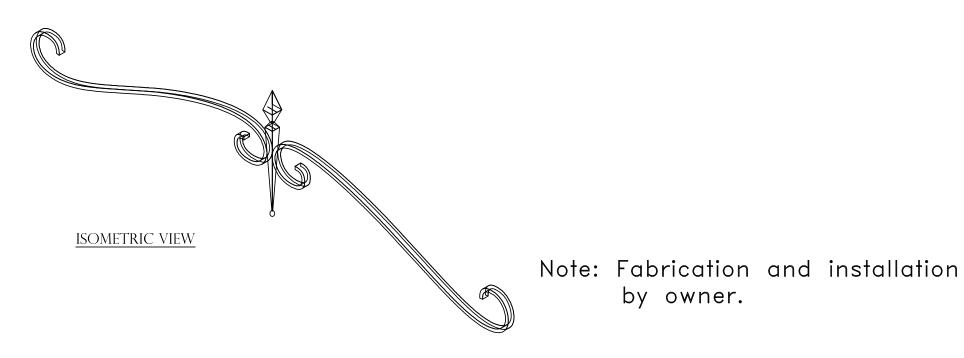



Mississippi State Univeristy Wayfinding and Signage Standards

# SHEET TITLE

BID-01 Neighborhood Gateway


SHEET NUMBER



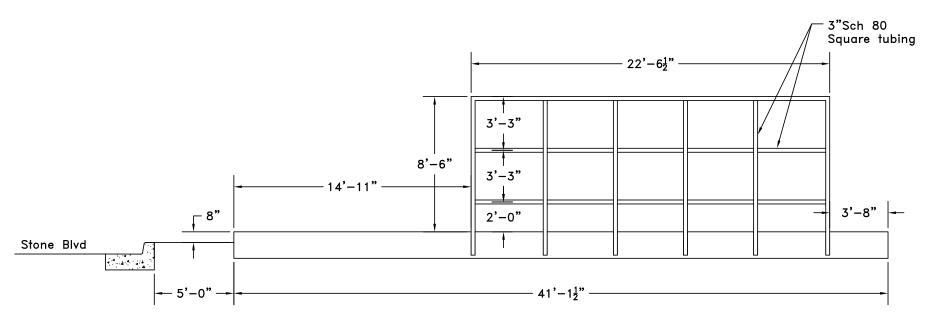

INTERNAL STEEL FRAME STRUCTURE RIGHT ELEVATION

TYPICAL SIDE ELEVATION

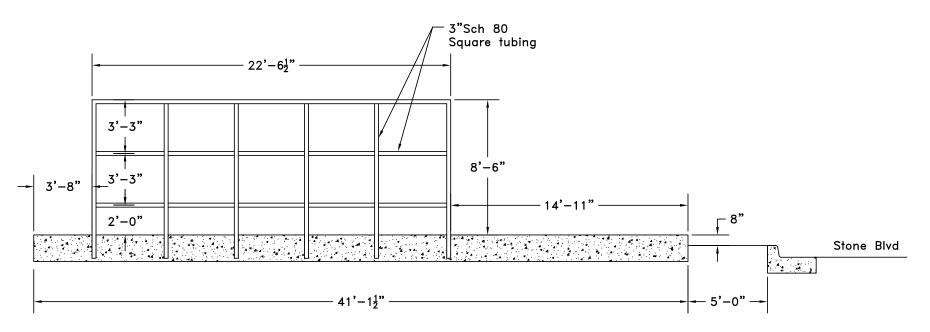

INTERNAL STEEL FRAME STRUCTURE LEFT ELEVATION

Note: Fabrication and installation by owner.

DATE

February 17, 2023

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PROJECT NAME

Mississippi State Univeristy Wayfinding and Signage Standards

SHEET TITLE

Existing Gateway Entry

SHEET NUMBER